Democratic Socialist Republic of Sri Lanka

## **Ministry of Defence**







National Building Research Organization (NBRO)



Reduction of Landslide Vulnerability by Mitigation Measures Project (RLVMMP) funded by
Asian Infrastructure Investment Bank (AIIB)

(Loan No: L0124A)

# **DRAWINGS**

Landslide Mitigation Measures at 05 Locations in Nuwara Eliya District (Site no. 42, 43, 44, 101 & 103) under Package 6A of Reduction of Landslide Vulnerability by Mitigation Measures Project (RLVMMP) RFT No: RLVMMP/WORKS/06A

March. 2024





## **DESIGN NOTATION**

SOIL NAILING AREA I 0 0 0 0 0 0 0

A A A A A SOIL NAILING AREA II

35050 GABION WALL (TYPE II)

5000 GABION WALL (TYPE III)

GABION WALL (TYPE V)

DS (M) - A

DS (M) - A (WITH COVER SLAB)

DS (M) - B

DS (M) - C

DS (M) - C (WITH COVER SLAB)

CATCH PIT

## **NOTES**

TITLE

- 1. SURFACE AND CASCADE DRAIN LOCATIONS (PATH) & LENGTHS MIGHT BE VARIED ACCORDING TO ACTUAL SITE CONDITION.
- 2. LOCATION OF THE CATCHPITS MIGHT BE VARIED ACCORDING TO THE ACTUAL SITE CONDITION.



DEMOCRATIC SOCIALIST REPUBLIC OF SRI LANKA STATE MINISTRY OF NATIONAL SECURITY AND DISASTER MANAGEMENT NATIONAL BUILDING RESEARCH ORGANISATION No. 99/1, JAWATTA ROAD, COLOMBO - 05

FROM HOUSES

(CSA)

(CS B

FROM NUMARABITYA

DESIGNER **DESIGN UNIT** NATIONAL BUILDING RESEARCH ORGANIZATION No. 99/1, JAWATTA ROAD, COLOMBO - 05

ROAD (H)

DUMP AREA

(CS08)

REVISION DESCRIPTION | APPROVAL PROJECT TITLE

TO WELLINGON

(cs c)

ROAD

STEPS

(CS01)


REDUCTION OF LANDSLIDE VULNERABILITY BY MITIGATION MEASURES SEETHA - ELIYA TEMPLE NUWARAELIYA

(CS02)

(CS03)

CS10

DESCRIPTION NAME SIGNATURE DRAWN K.M.D. NISHANTHI DESIGN PLAN VIEW DESIGNED P.A.D.L.S. CHANDRASIRI CHECKED H. R. MADURANGA SCALE 1:1000 DATE 01.02.2024 PROJECT / DRAWING No. APPROVED K.N. BANDARA RLVMMP/WORKS/NCB/PHII/042-HP/DR-03

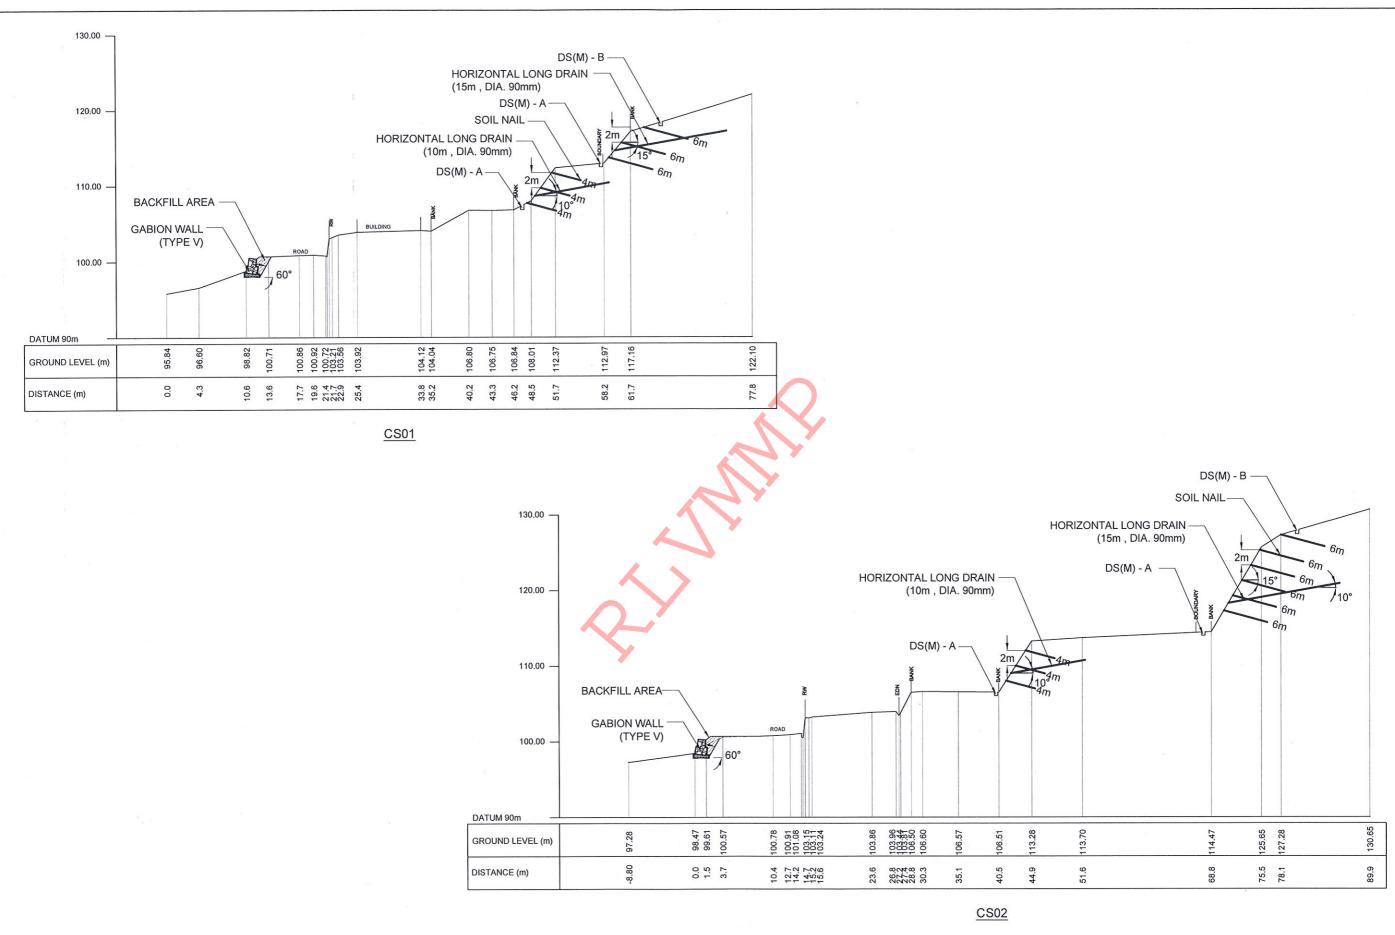

9 DEMOCRATIC SOCIALIST REPUBLIC OF SRI LANKA STATE MINISTRY OF NATIONAL SECURITY AND DISASTER MANAGEMENT NATIONAL BUILDING RESEARCH ORGANISATION No. 99/1, JAWATTA ROAD, COLOMBO - 05

EMPLOYER


	DESIGNER	_
г	DESIGN UNIT	
•	NATIONAL BUILDING RESEARCH (	0
	No. 99/1, JAWATTA RO	)
	COLOMBO - 05	

RGANIZATION			VUL
AD,			

REV DATE REVISION DESCRIPTION APPROVAL PROJECT TITLE

REDUCTION OF LANDSLIDE							
VULNERABILITY BY MITIGATION MEASURES							
SEETHA - ELIYA TEMPLE							
NUWARAELIYA							

	TITLE			DESCRIPTION	NAME	SIGNATURE
DESIGN CROSS SECTION				DRAWN	K.M.D. NISHANTHI	Je Je
	DESIGN GROSS SECTION			DESIGNED	P.A.D.L.S. CHANDRASIRI	Jela
	SCALE 1:500	01.02.2024	CHECKED	H. R. MADURANGA	Panh	
	DRO JECT / DRAWING No.   REVISION			APPROVED	K.N. BANDARA	

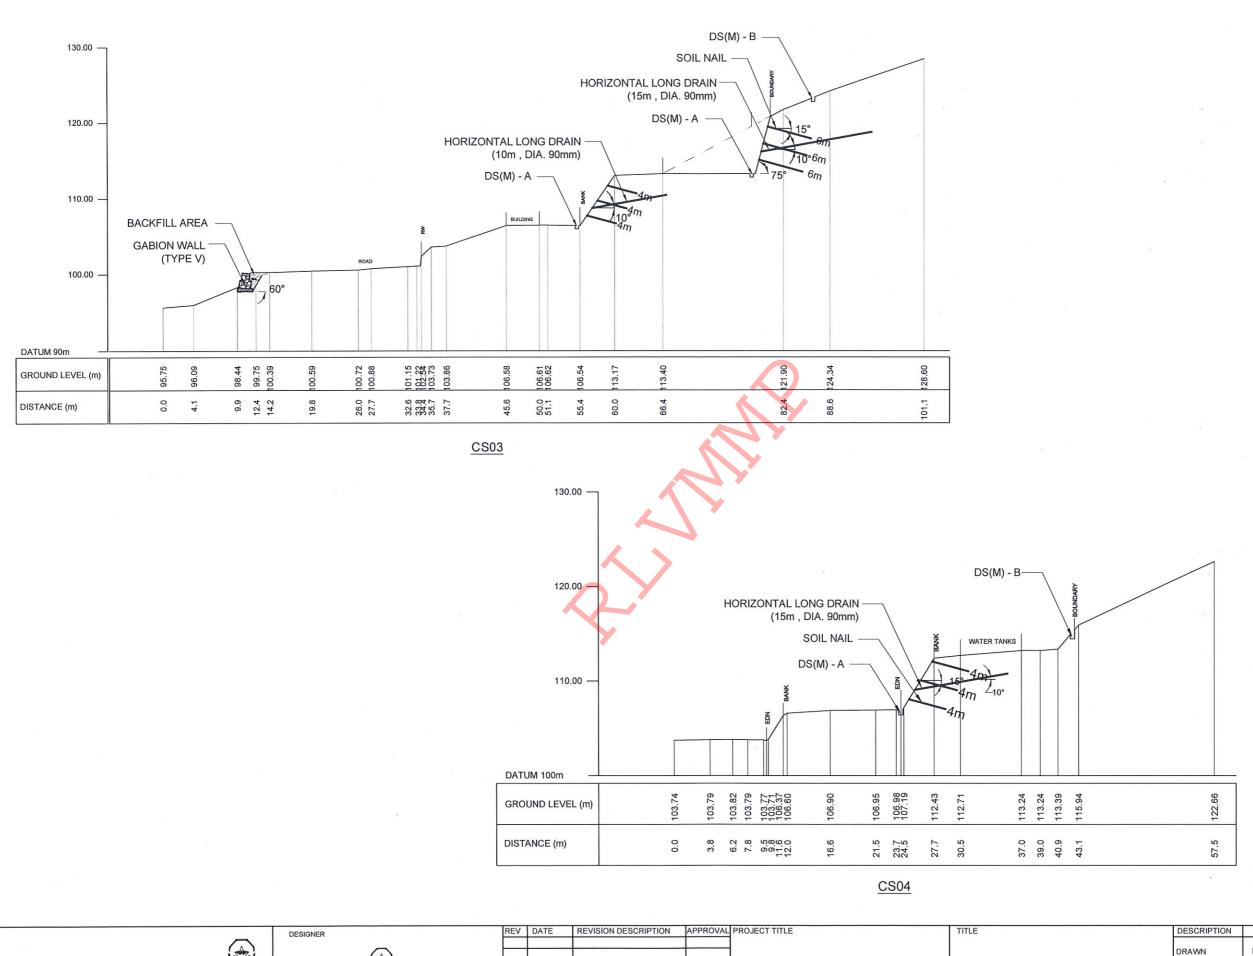

DEMOCRATIC SOCIALIST REPUBLIC OF SRI LANKA
STATE MINISTRY OF NATIONAL SECURITY AND DISASTER MANAGEMENT
NATIONAL BUILDING RESEARCH ORGANISATION
No. 99/1, JAWATTA ROAD,
COLOMBO - 05

EMPLOYER

DESIGN UNIT
NATIONAL BUILDING RESEARCH ORGANIZATION
No. 99/1, JAWATTA ROAD,
COLOMBO - 05

REDUCTION OF LA

VULNERABILITY BY MITIG

SEETHA - ELIYA

NUWARAEL

REDUCTION OF LANDSLIDE

VULNERABILITY BY MITIGATION MEASURES


SEETHA - ELIYA TEMPLE


NUWARAELIYA

SCALE


PROJECT


1	TITLE			DESCRIPTION	NAME	SIGNATURE
DESIGN CROSS SECTION				DRAWN	K.M.D. NISHANTHI	100
	BESIGN GROSS SECTION			DESIGNED	P.A.D.L.S. CHANDRASIRI	la
				CHECKED	H. R. MADURANGA	169 W
	SCALE 1:400, 1:500	DATE	01.02.2024	OTILOTILD	TI. N. WADONANGA	160
	PROJECT / DRAWING No. REVISION		APPROVED	K.N. BANDARA		
	RLVMMP/WORKS/NCB/PHII/042-HP/DR-04b 00			APPROVED N.N. BANDARA		

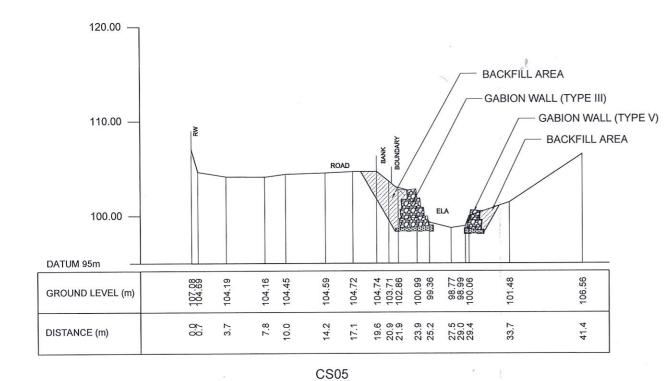

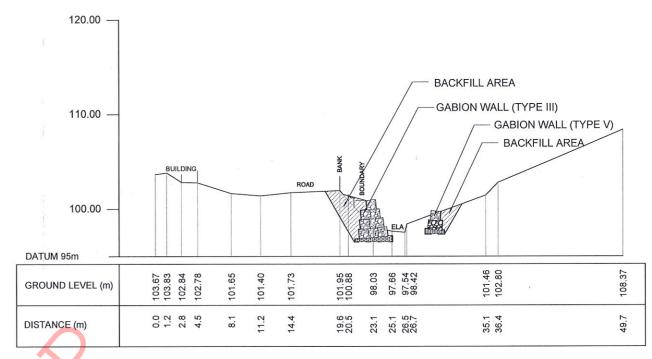


CS06

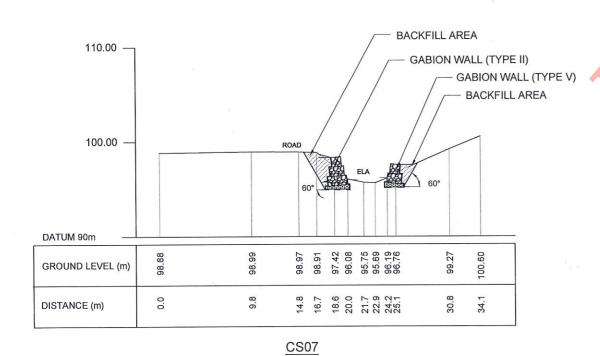

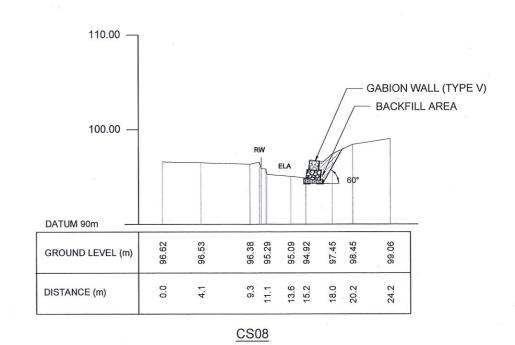

DESCRIPTION NAME SIGNATURE REVISION DESCRIPTION APPROVAL PROJECT TITLE REV DATE DESIGNER **EMPLOYER** K.M.D. NISHANTHI DRAWN DESIGN CROSS SECTION REDUCTION OF LANDSLIDE DEMOCRATIC SOCIALIST REPUBLIC OF SRI LANKA P.A.D.L.S. CHANDRASIRI DESIGNED DESIGN UNIT
NATIONAL BUILDING RESEARCH ORGANIZATION
No. 99/1, JAWATTA ROAD,
COLOMBO - 05 VULNERABILITY BY MITIGATION MEASURES STATE MINISTRY OF NATIONAL SECURITY AND DISASTER MANAGEMENT NATIONAL BUILDING RESEARCH ORGANISATION SEETHA - ELIYA TEMPLE CHECKED H. R. MADURANGA DATE 01.02.2024 No. 99/1, JAWATTA ROAD, NUWARAELIYA PROJECT / DRAWING No. APPROVED K.N. BANDARA COLOMBO - 05 RLVMMP/WORKS/NCB/PHII/042-HP/DR-04c

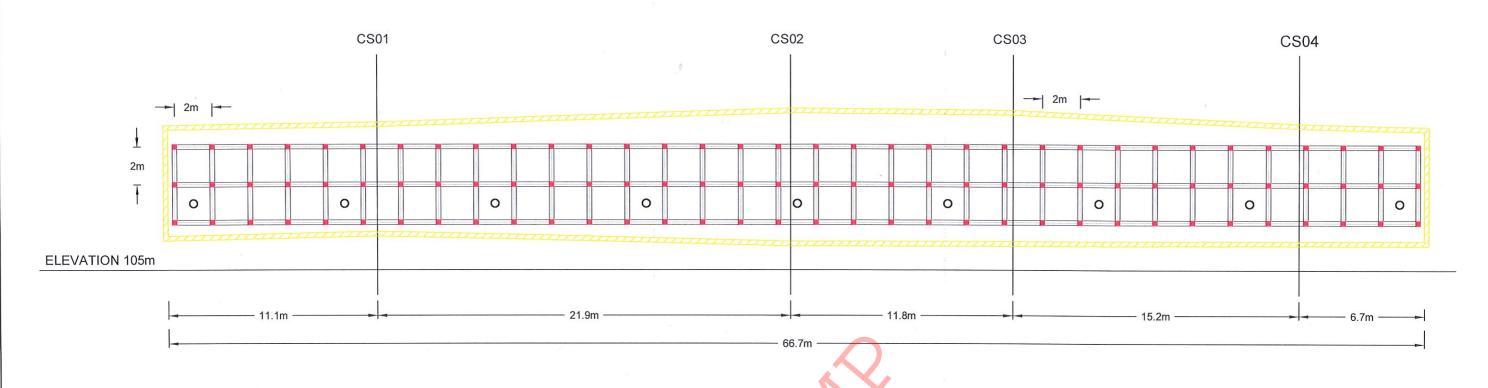

## FRONT ELEVATION OF SOIL NAILING AREA I

LEGEND

SOIL NAILING

TOTAL SOIL NAIL LENGTH = 04m

NO OF SOIL NAIL = 102
REINFORCEMENT DIAMETER = 32 mm
DIAMETER OF DRILLED HOLE = 125mm

NAIL SPACING = 2m (BW)


HORIZONTAL LONG DRAIN -

HORIZONTAL LONG DRAIN LENGTH = 10 m NO'S OF LONG DRAIN = 09

NO'S OF LONG DRAIN DIAMETER = 90 mm SPACING = 08 m

**BOUNDARY BEAM** 

DESCRIPTION EMPLOYER NAME SIGNATURE DESIGNER DRAWN K.M.D. NISHANTHI REDUCTION OF LANDSLIDE FRONT ELEVATION DEMOCRATIC SOCIALIST REPUBLIC OF SRI LANKA DESIGNED P.A.D.L.S. CHANDRASIRI **DESIGN UNIT** VULNERABILITY BY MITIGATION MEASURES STATE MINISTRY OF NATIONAL SECURITY AND DISASTER MANAGEMENT NATIONAL BUILDING RESEARCH ORGANIZATION NATIONAL BUILDING RESEARCH ORGANISATION SEETHA - ELIYA TEMPLE No. 99/1, JAWATTA ROAD, CHECKED H. R. MADURANGA SCALE 1:200 No. 99/1, JAWATTA ROAD, DATE 01.02.2024 COLOMBO - 05 NUWARAELIYA PROJECT / DRAWING No. REVISION COLOMBO - 05 APPROVED K.N. BANDARA 00 RLVMMP/WORKS/NCB/PHII/042-HP/DR-05a

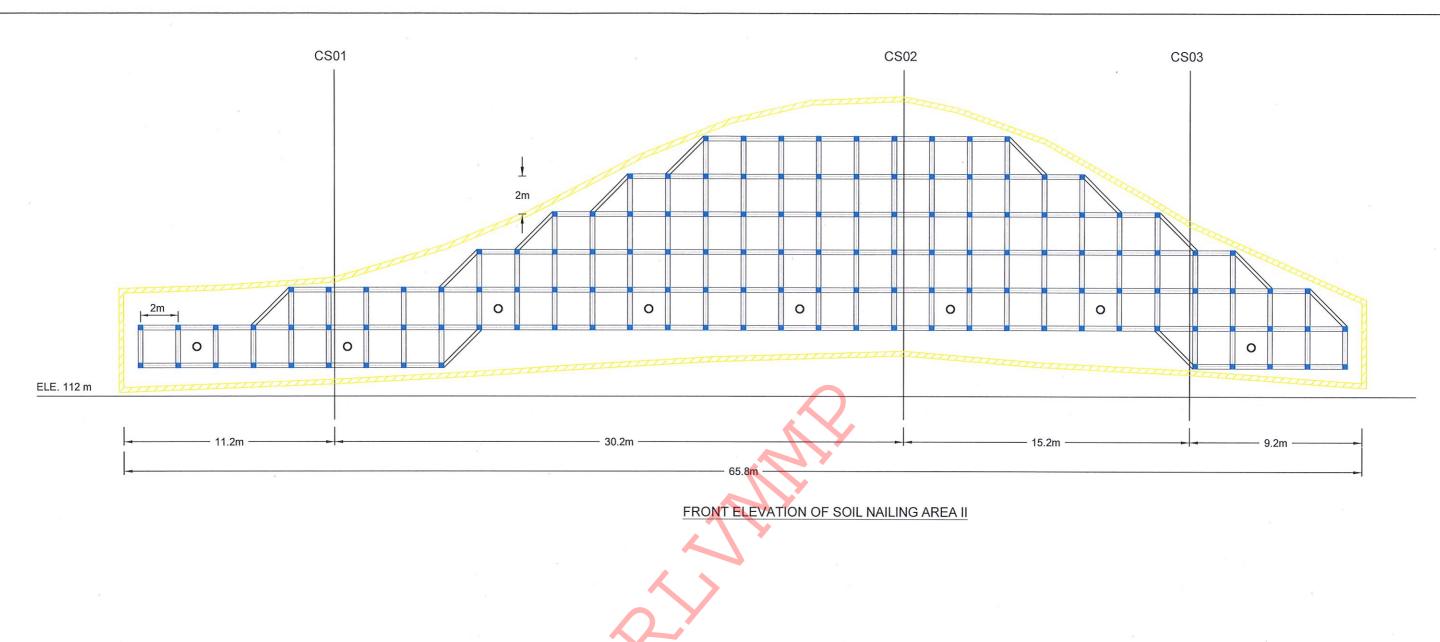

LEGEND

SOIL NAILING

TOTAL SOIL NAIL LENGTH = 6m NO OF SOIL NAIL = 135

REINFORCEMENT DIAMETER = 32 mm DIAMETER OF DRILLED HOLE = 125mm NAIL SPACING = 2m (BW)

HORIZONTAL LONG DRAIN

HORIZONTAL LONG DRAIN LENGTH = 15 m NO'S OF LONG DRAIN = 08

DIAMETER = 90 mm SPACING = 08 m

BOUNDARY BEAM


EMPLOYER ***
DEMOCRATIC SOCIALIST REPUBLIC OF SRI LANKA
STATE MINISTRY OF NATIONAL SECURITY AND DISASTER MANAGEMENT
NATIONAL BUILDING RESEARCH ORGANISATION
No. 99/1, JAWATTA ROAD,
COLOMBO - 05

DESIGN UNIT
NATIONAL BUILDING RESEARCH ORGANIZATION
No. 99/1, JAWATTA ROAD,
COLOMBO - 05


DESIGNER


	DATE	REVISION DESCRIPTION	APPROVAL	PROJECT TITLE
		×		
			+	REDUCTION OF LANDSLIDE
				VULNERABILITY BY MITIGATION MEASURES
-				SEETHA - ELIYA TEMPLE
				NUWARAELIYA


FRONT ELEVATION				DESCRIPTION	NAME	SIGNATURE
			DRAWN	K.M.D. NISHANTHI	Je.	
				DESIGNED	P.A.D.L.S. CHANDRASIRI	lely
				OUEQUED		Daile
CALE	1:200	DATE	01.02.2024	CHECKED	H. R. MADURANGA	Kosir
PROJECT / DRAWING No. REVISION LVMMP/WORKS/NCB/PHII/042-HP/DR-05b 00			REVISION 00	APPROVED	K.N. BANDARA	Will

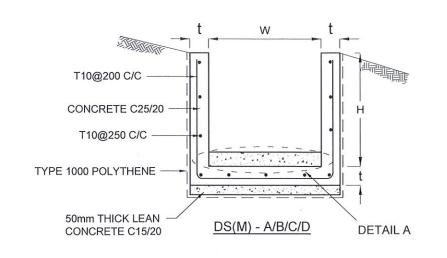


DRAIN TYPE	W (mm)	H (mm)	t (mm)
DS (M) - A /P	300	300	100
DS (M) - B/R	450	450	100
DS (M) - C/Q	600	600	100
DS (M) - D	750	750	125
DS (M) - E	900	900	150
DS (M) - F	1000	1000	150

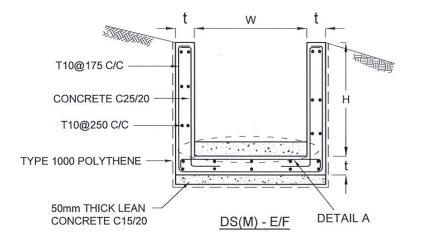

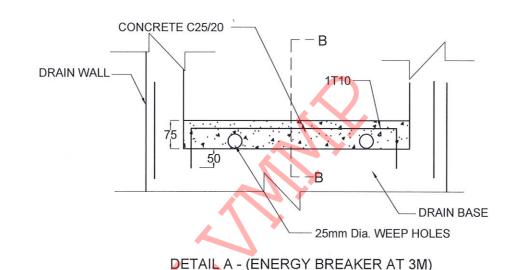

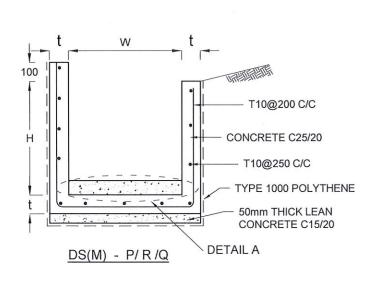

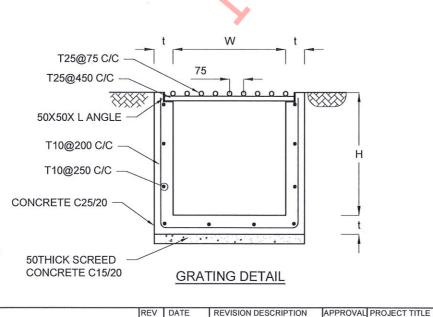

#### NOTES


- . DEPTH OF EXCAVATION MAY VARY ACCORDING TO SITE CONDITIONS.
- 2. STEPS SHALL BE CONSTRUCTED AT SURFACE DRAIN ON SLOPING GROUND ACCORDING TO THE SITE CONDITIONS AS INSTRUCTED BY THE ENGINEER.
- 3. ENERGY BREAKERS SHALL BE CONSTRUCTED AT THE STEEP DRAIN SEGMENTS AS PER THE INSTRUCTIONS OF THE ENGINEER.
- 4. DOWELS SHALL BE INSTALLED ACCORDING TO THE GROUND CONDITIONS AS INSTRUCTED BY THE ENGINEER.
- 5. ALL DIMENSIONS ARE IN MILLIMETERS UNLESS OTHERWISE STATED.
- 10 mm THICK EXPANSION JOINT SHALL BE INTRODUCED IN EVERY 5m INTERVAL.

#### CONCRETE

- USE FOLLOWING CONCRETE GRADES FOR STRUCTURE
  - [a] SCREED C. 15/20
  - [b] WALLS / BASE / ENERGY BREAKERS C. 25/20

#### REINFORCEMENT

- 8. ALL BARS MARKED "T" SHALL BE HIGH YIELD DEFORMED BARS OF YIELD STRENGTH NOT LESS THAN 460N/mm².
- BARS OF CUT LENGTH LARGER THAN THE SUPPLIED LENGTH TO BE LAPPED FOR A LENGTH OF 50 x BAR DIA. AND LAPPING SHOULD BE STAGGERED.
- ANCHORAGE LENGTH SHOULD BE 40X BAR DIA.
- REINFORCEMENT BARS SHALL BE BENT IN ACCORDANCE WITH STANDARD SPECIFICATIONS.
- COVER TO REINFORCEMENT
  - [a] BURIED FACES AND DRAIN INVERTS
  - [b] ALL OTHER FACES
- 40 mm - 25 mm

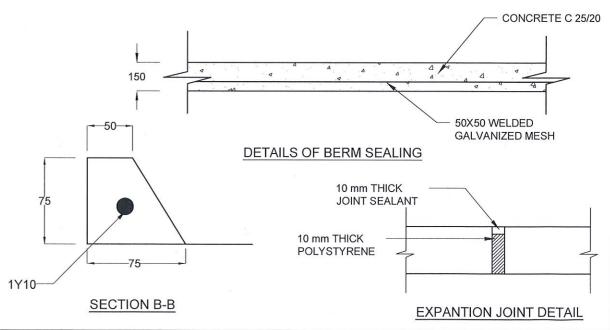

EMPLOYER

DEMOCRATIC SOCIALIST REPUBLIC OF SRI LANKA MINISTRY OF DEFENCE NATIONAL BUILDING RESEARCH ORGANISATION No. 99/1, JAWATTA ROAD, COLOMBO - 05

DESIGNER

DESIGN UNIT
NATIONAL BUILDING RESEARCH ORGANISATION
No. 99/1, JAWATTA ROAD,
COLOMBO - 05

RE VULNERABI

REDUCTION OF LANDSLIDE

VULNERABILITY BY MITIGATION MEASURES

SEETHA - ELIYA TEMPLE

NUWARAELIYA

DETAILS OF DRAINS
(SURFACE DRAIN -1 OF 2)

SCALE N.T.S. DATE 01.02.2024

PROJECT / DRAWING No.

RLVMMP/WORKS/NCB/PHII/042-HP/DR-06a


DESCRIPTION NAME SIGNATURE


DRAWN K.M.D. NISHANTHI


DESIGNED P.A.D.L.S. CHANDRASIRI

CHECKED H. R. MADURANGA

N APPROVED K.N. BANDARA

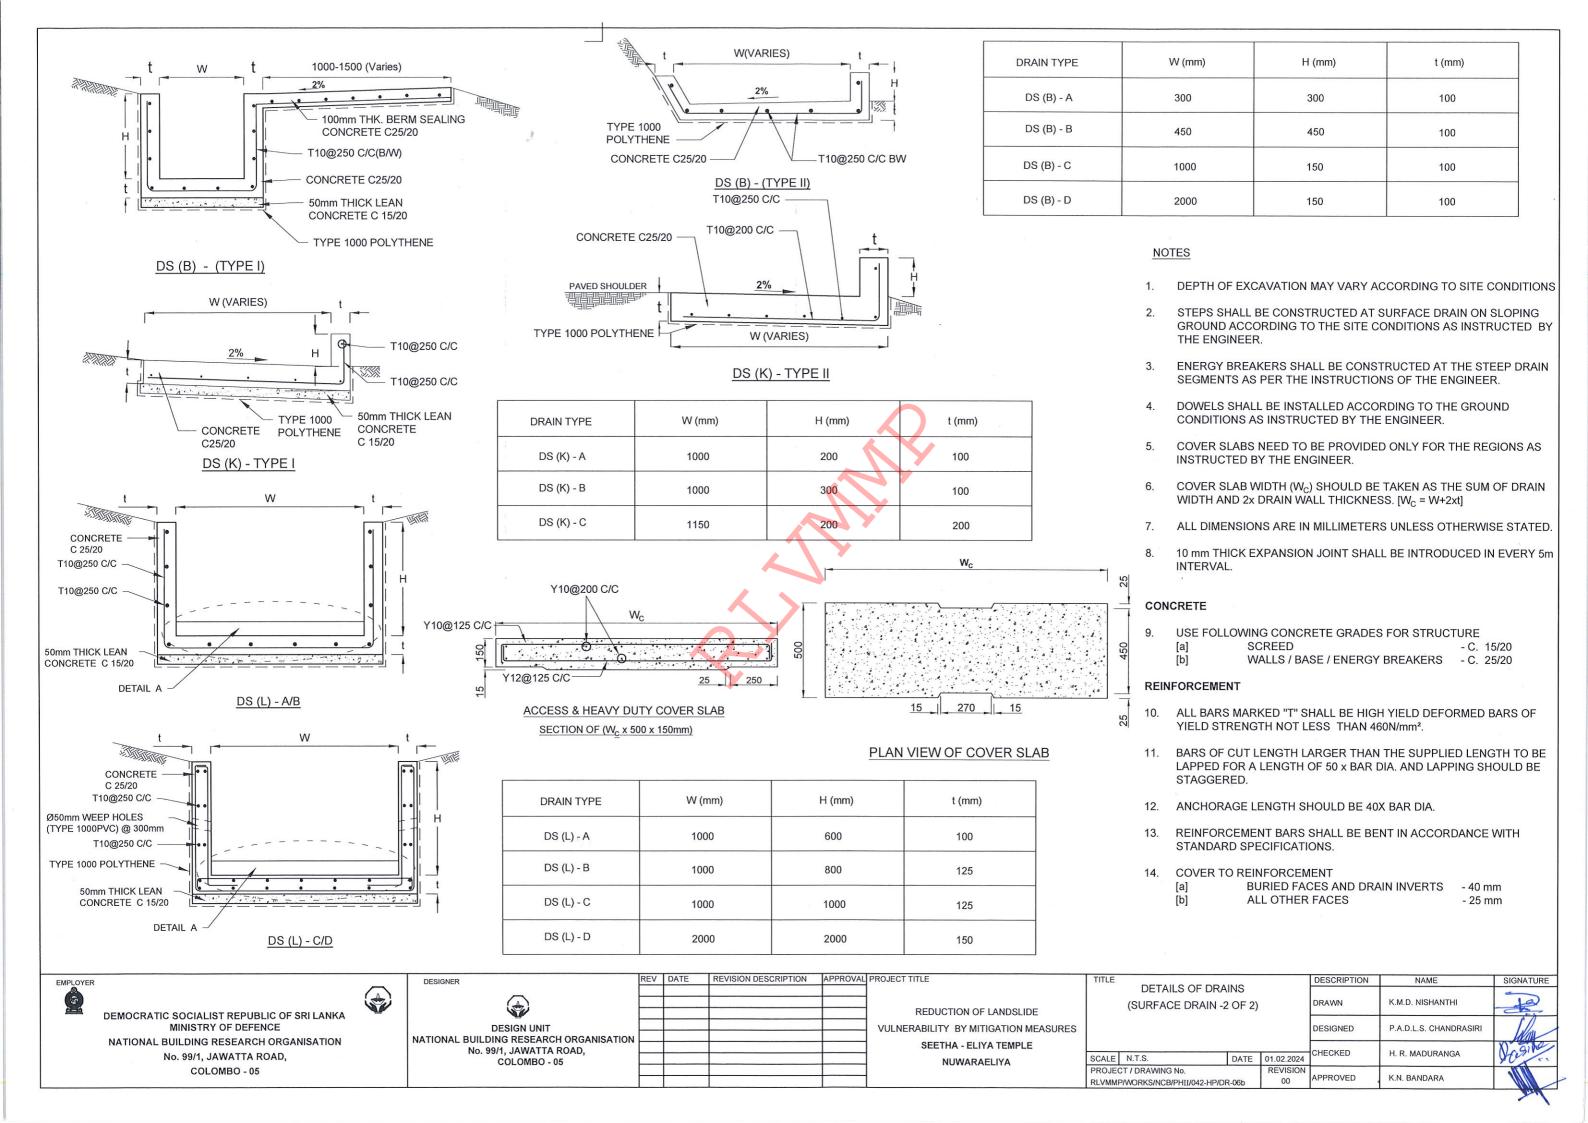


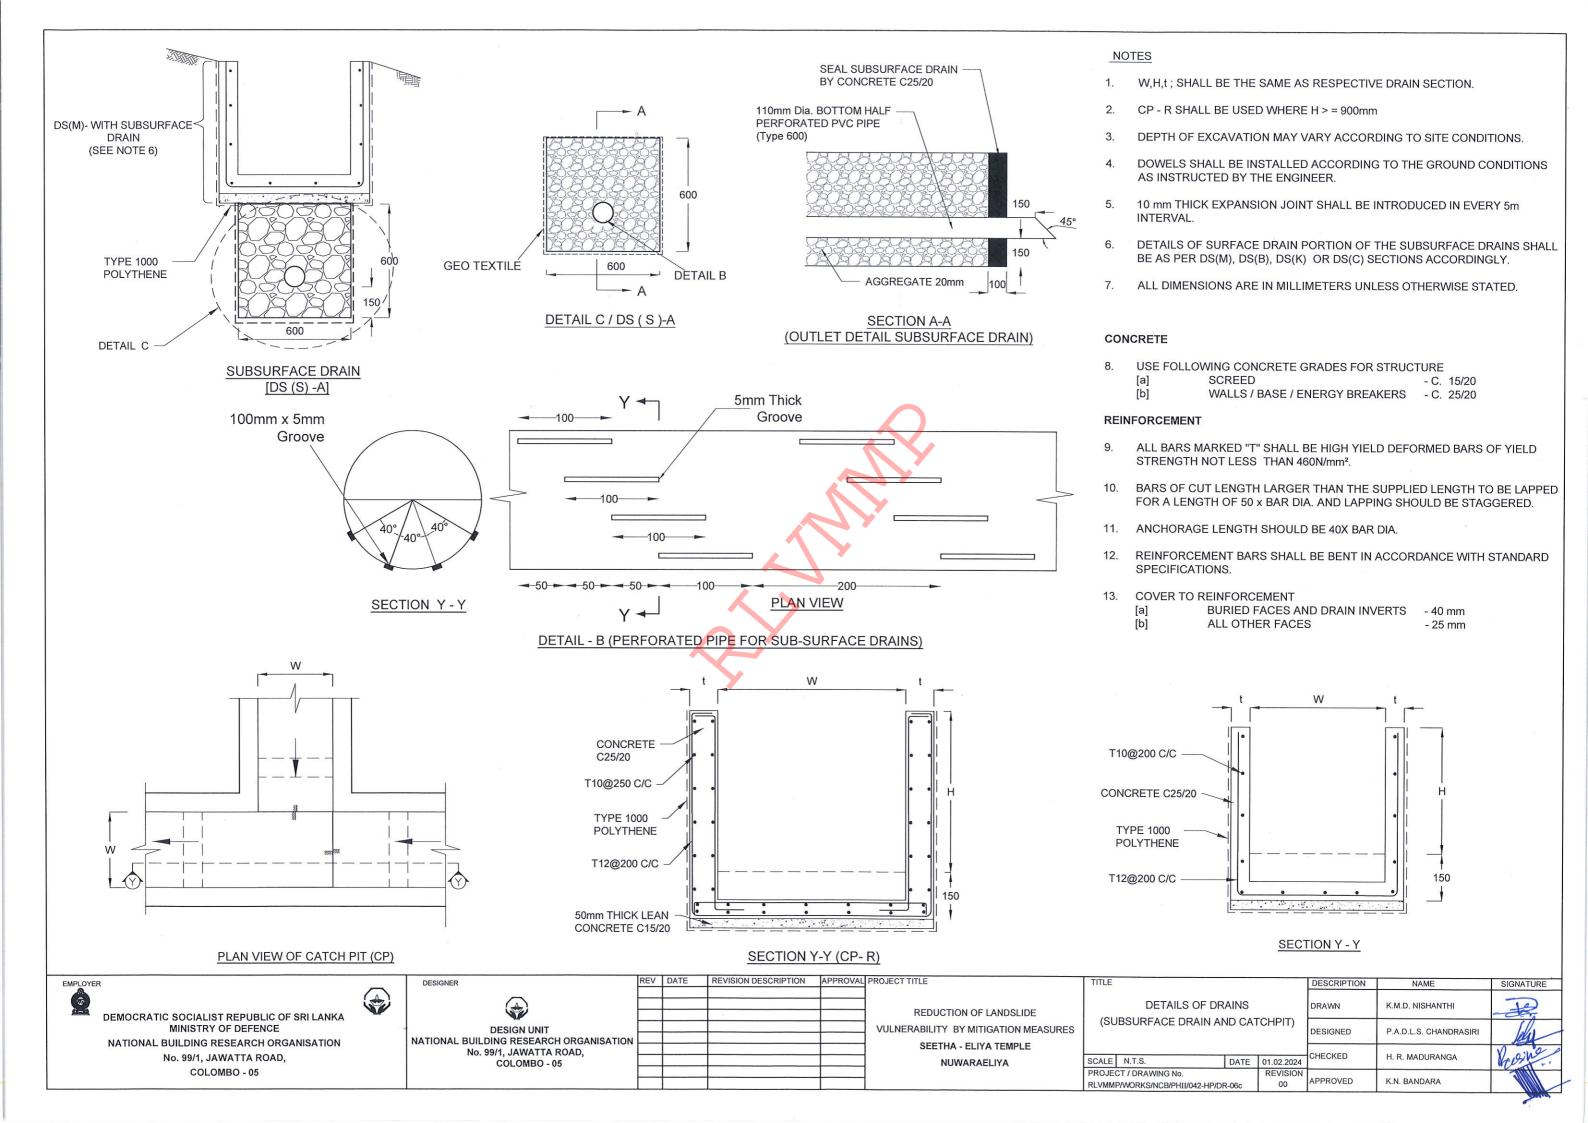


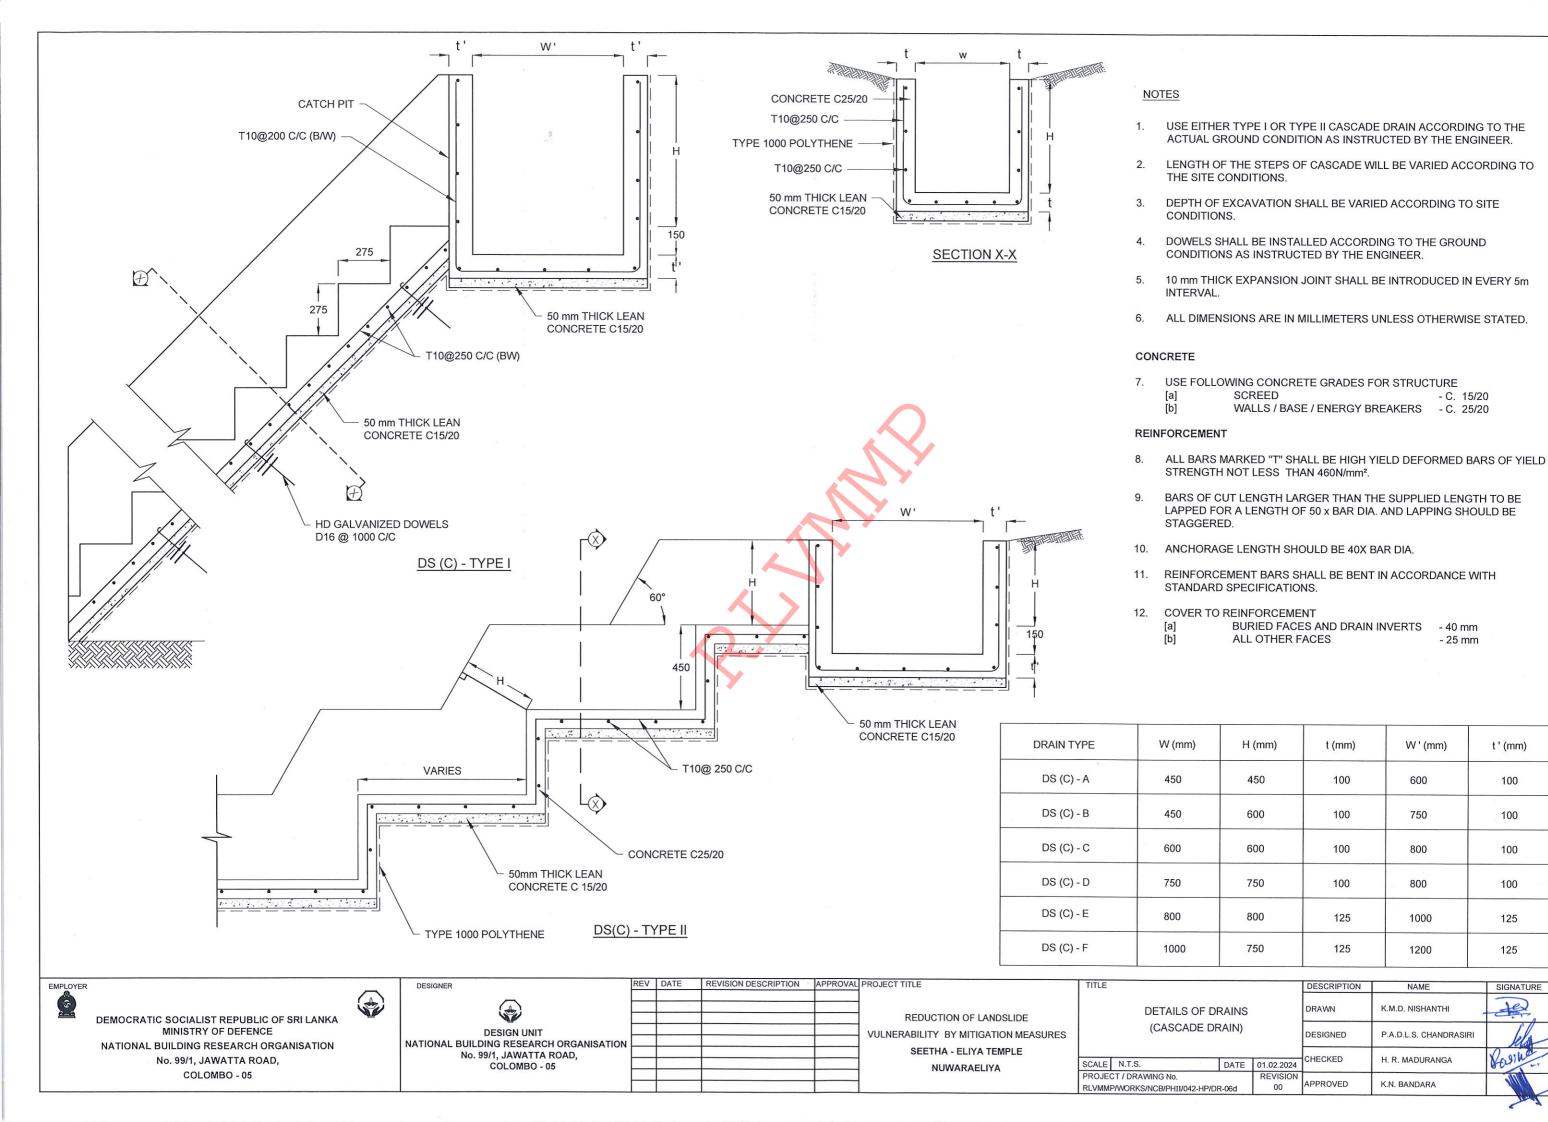

t' (mm)

SIGNATURE

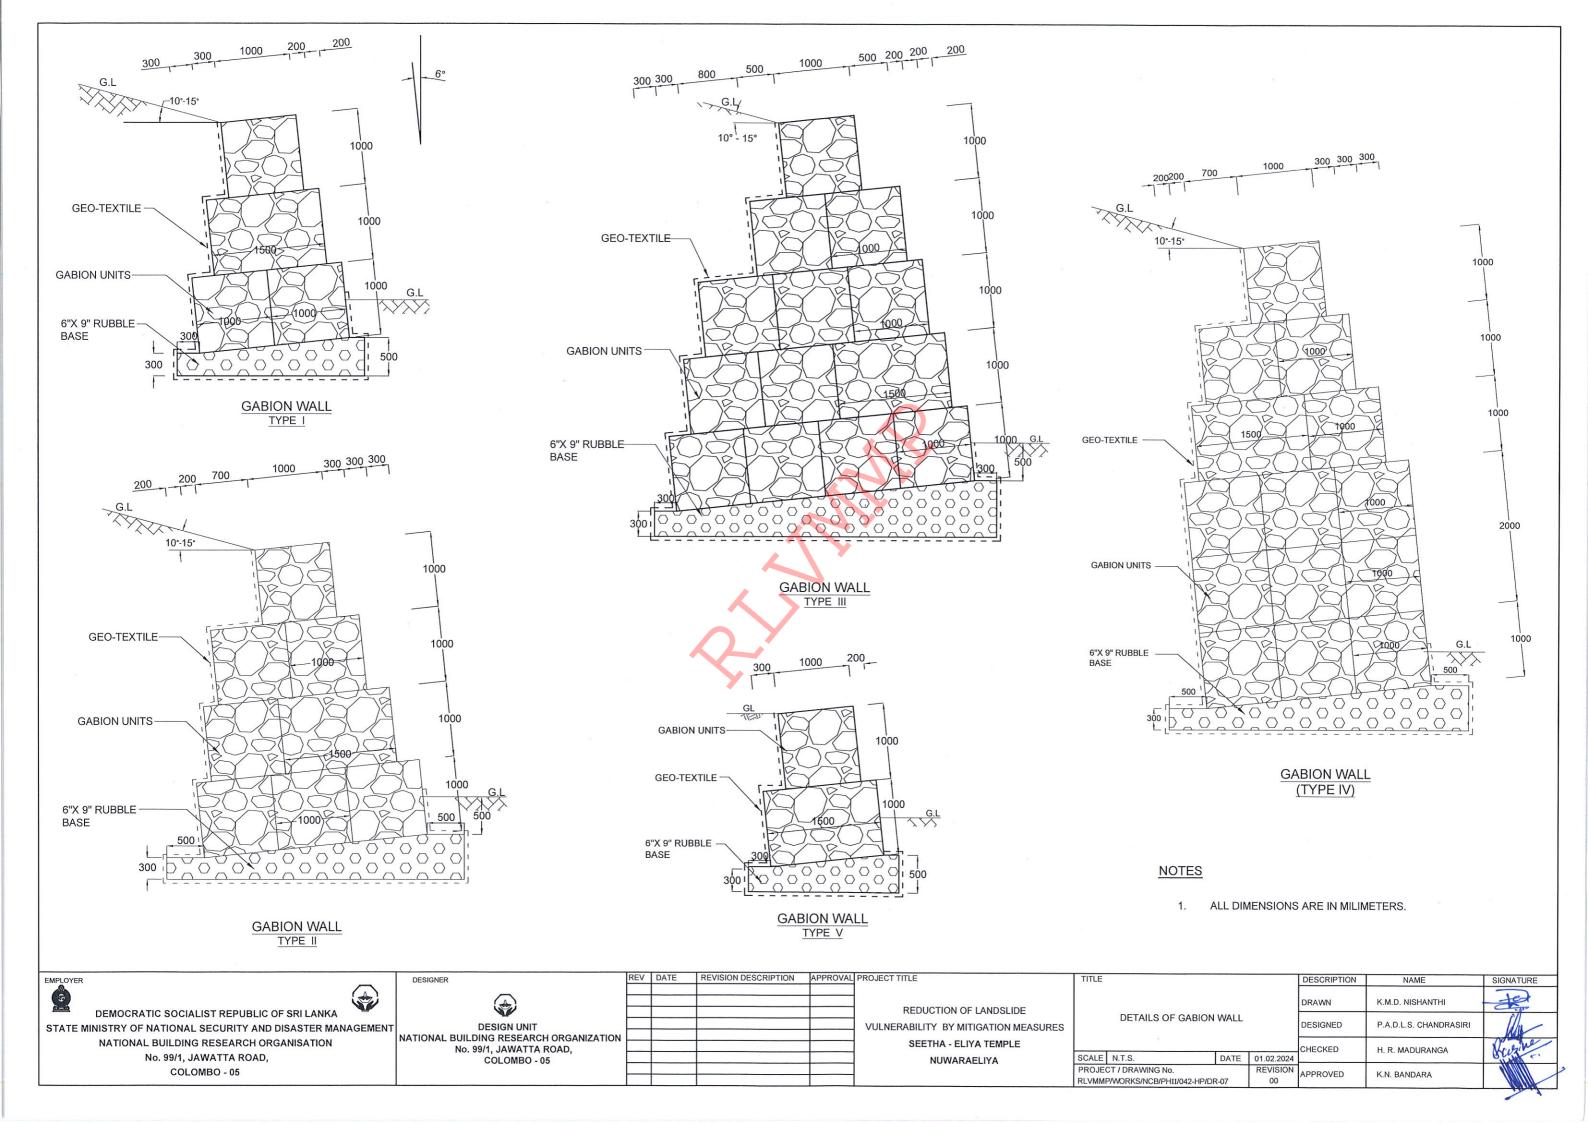

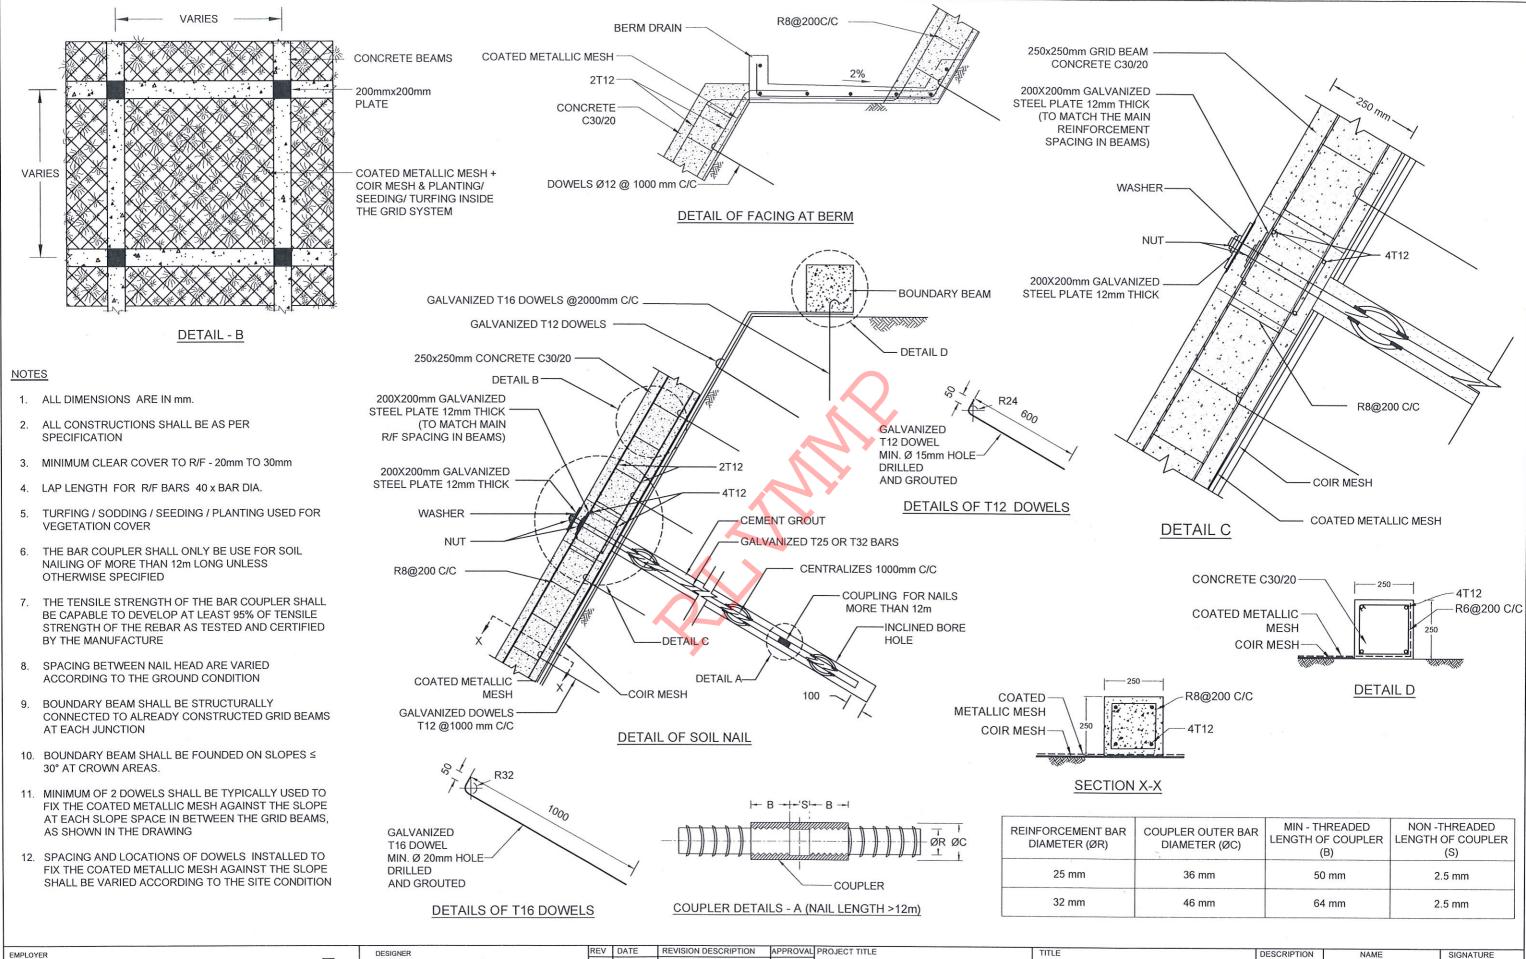

DEMOCRATIC SOCIALIST REPUBLIC OF SRI LANKA STATE MINISTRY OF NATIONAL SECURITY AND DISASTER MANAGEMENT NATIONAL BUILDING RESEARCH ORGANISATION No. 99/1, JAWATTA ROAD, COLOMBO - 05

**DESIGN UNIT** NATIONAL BUILDING RESEARCH ORGANIZATION No. 99/1, JAWATTA ROAD, COLOMBO - 05

REDUCTION OF LANDSLIDE VULNERABILITY BY MITIGATION MEASURES SEETHA - ELIYA TEMPLE NUWARAELIYA

DETAILS OF SOIL NAILING WITH NON EMBEDDED GRID BEAM SCALE N.T.S.

PROJECT / DRAWING No.


RLVMMP/WORKS/NCB/PHII/042-HP/DR-08


DATE 01.02.2024

REVISION

00

DRAWN K M D NISHANTHI DESIGNED P.A.D.L.S. CHANDRASIR CHECKED H. R. MADURANGA APPROVED

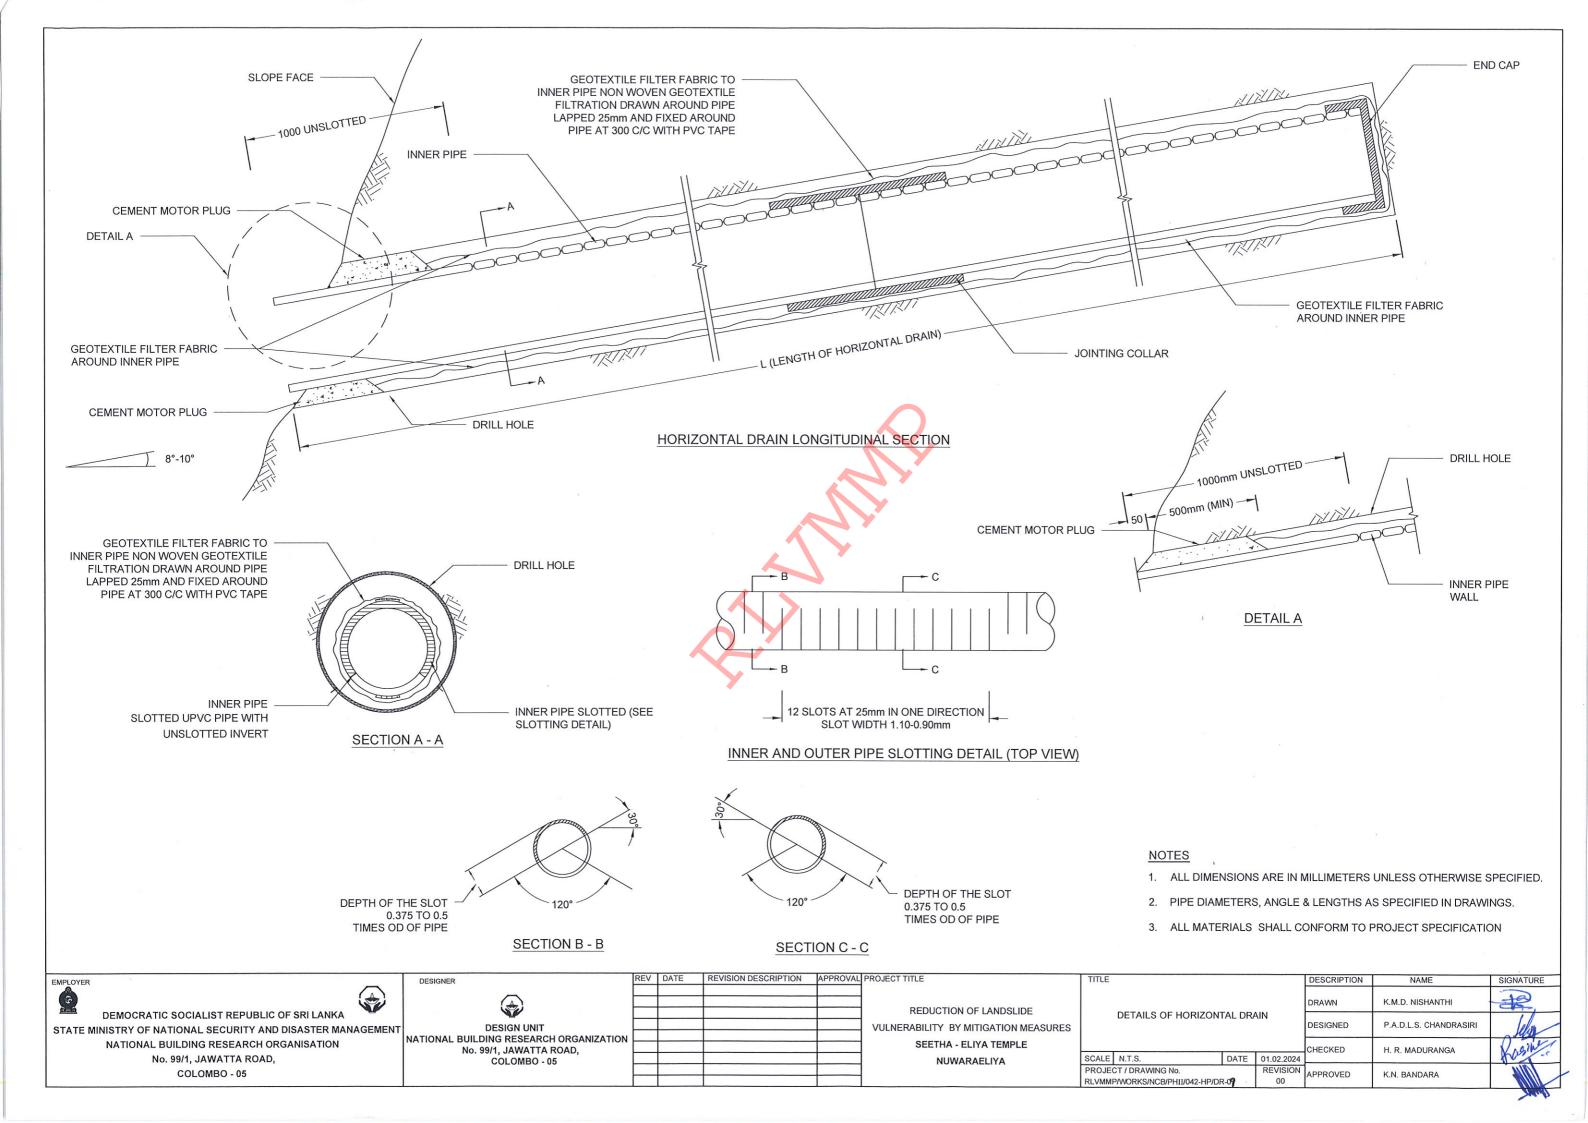

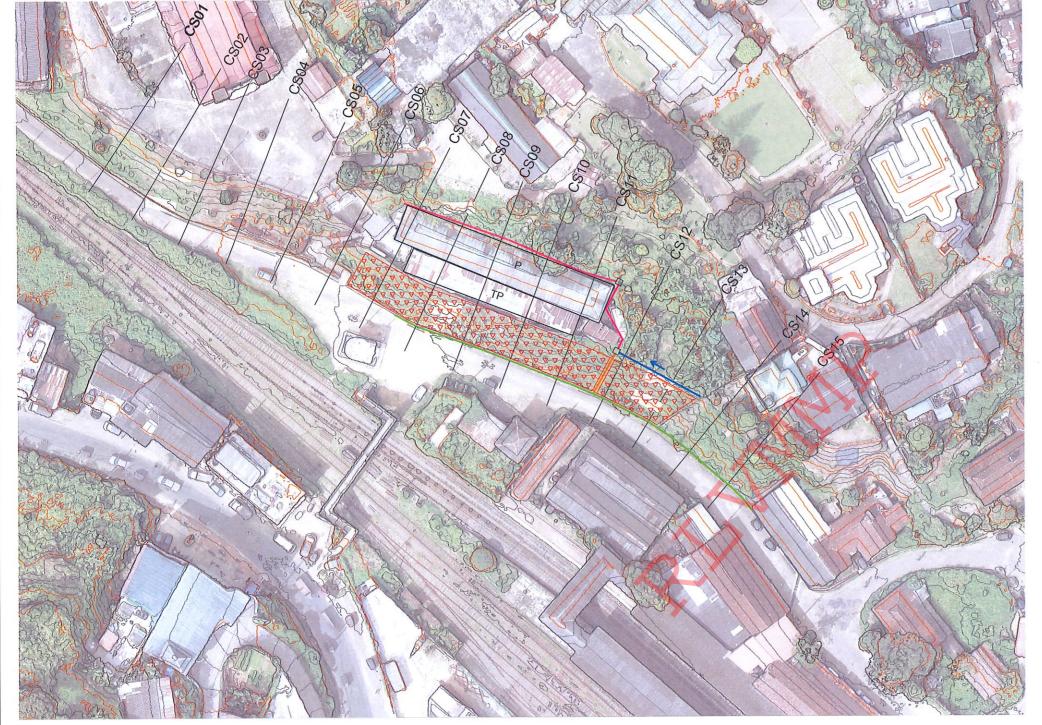

## REFERENCE

PERMANENT BUILDING

- TEMPORARY BUILDING

## DESIGN NOTATION

- DS (M) - A

- DS (M) - B

- DS (M ) - C (EXISTING)

REFURBISH EXISTING RRM DRAIN

- SOIL NAIL

☐ - CATCH PIT

## NOTES

- SURFACE AND CASCADE DRAINS LOCATIONS (PATH OF THE DRAINS) & LENGTH MIGHT BE VARIED ACCORDING TO ACTUAL SITE CONDITION.
- 2. THE NUMBER OF NAILS, NAILS LENGTH AND NAIL LOCATION MAY BE VARIED ACCORDING TO THE ACTUAL SITE CONDITIONS.
- 3. THE SIDE DRAIN (DS (M) B ) SHALL BE DIRECTED TO THE NATURAL VALLEY AND EXISTING CULVERT.
- 4. THE OVERHANGING / UNSTABLE ROCK EXPOSURES SHALL BE REMOVED BY TRIMMING OR SCALING.

DEMOCRATIC SOCIALIST REPUBLIC OF SRI LANKA
STATE MINISTRY OF NATIONAL SECURITY AND DISASTER MANAGEMENT
NATIONAL BUILDING RESEARCH ORGANISATION
No. 99/1, JAWATTA ROAD,
COLOMBO - 05


EMPLOYER

DESIGN UNIT
NATIONAL BUILDING RESEARCH ORGANIZATION
No. 99/1, JAWATTA ROAD,
COLOMBO - 05

REV DATE REVISION DESCRIPTION APPROVAL
PROJECT TITLE

REDUCTION OF LANDSLIDE
VULNERABILITY BY MITIGATION MEASURES
BOSCO COLLEGE - HATTON

П	TITLE		DESCRIPTION	NAME	SIGNATURE	
١				DRAWN	S.A.G.D. SENANAYAKA	Garjan
1	DESIGN PLAN VI		DESIGNER	D.M.D.T. DASANAYAKA	South	
				CHECKED	B.I. KUMARAGE	ant.
ŀ				BECOMMENDED	B ( 0 1 0 1/1 1 TI III 1 I/1	W.
-	SCALE 1:750	DATE	11.05.2022	RECOMMENDED	Prof. S.A.S. KULATHILAKA	
ſ	PROJECT / DRAWING No.		REVISION	ADDDOVED.	VII BINDIDI	MINI
	RLVMMP/WORKS/NCB/PHII/043-BO/DR-03 00			APPROVED	K.N. BANDARA	

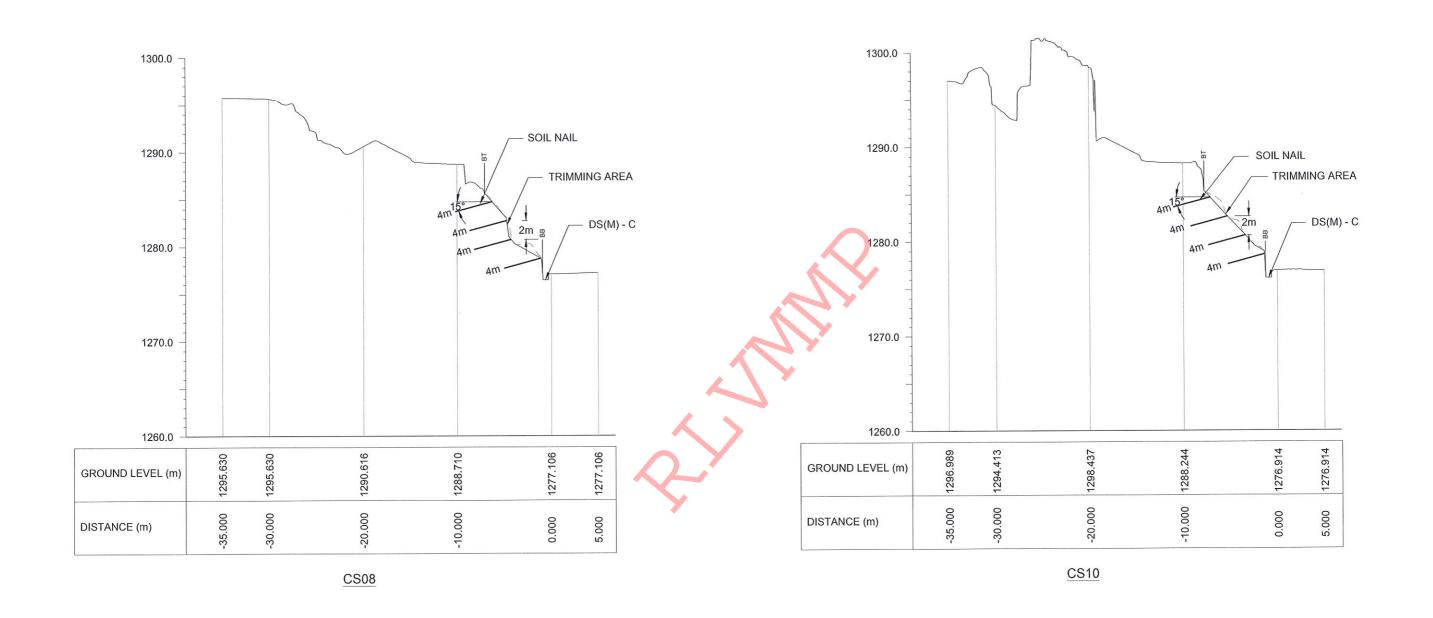

DEMOCRATIC SOCIALIST REPUBLIC OF SRI LANKA	
STATE MINISTRY OF NATIONAL SECURITY AND DISASTER MANAGEMEN	т
NATIONAL BUILDING RESEARCH ORGANISATION	ا
No. 99/1, JAWATTA ROAD,	
COLOMBO - 05	

DESIGN UNIT
NATIONAL BUILDING RESEARCH ORGANIZATION
No. 99/1, JAWATTA ROAD,
COLOMBO - 05

DESIGNER


REDUCTION OF LANDSLIDE

VULNERABILITY BY MITIGATION MEASURES


BOSCO COLLEGE - HATTON

REV DATE REVISION DESCRIPTION APPROVAL PROJECT TITLE

-	TITLE			DESCRIPTION	NAME	SIGNATURE
				DRAWN	S.A.G.D. SENANAYAKA	Goops
	DESIGN CROSS SE	CTION		DESIGNER	D.M.D.T. DASANAYAKA	Souther
				CHECKED	B.I. KUMARAGE	Aust -
SCALE 1:500 DA		DATE	11.05.2022	RECOMMENDED	Prof. S.A.S. KULATHILAKA	X
	PROJECT / DRAWING No. RLVMMP/WORKS/NCB/PHII/043-BO/DR	-04a	REVISION 00	APPROVED	K.N. BANDARA	

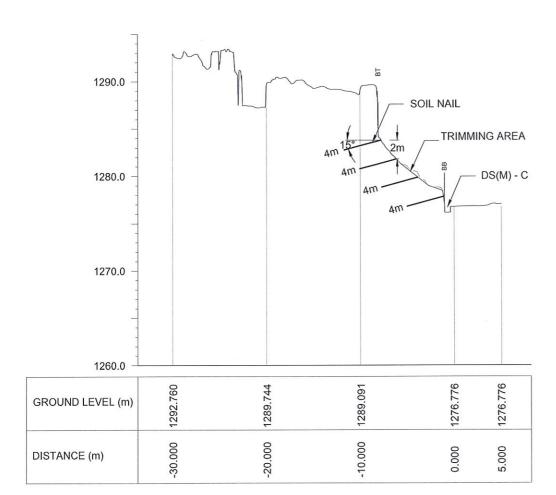

CS12

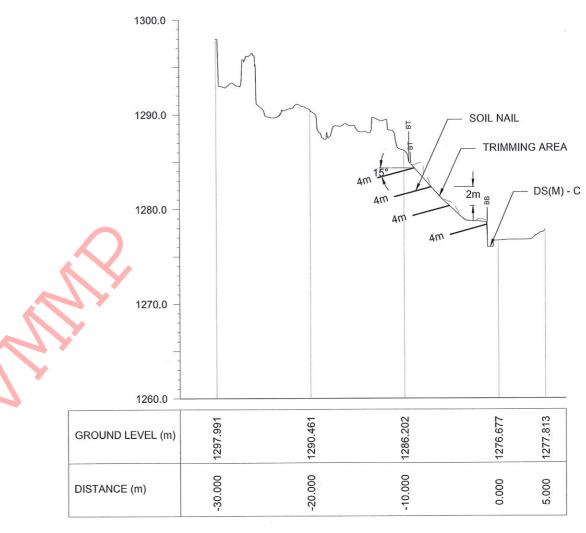

CS13


EMPLOYER	
DEMOCRATIC SOCIALIST REPUBLIC OF SRI LANKA	١
STATE MINISTRY OF NATIONAL SECURITY AND DISASTER MANAGEMENT	1
NATIONAL BUILDING RESEARCH ORGANISATION	ľ
No. 99/1, JAWATTA ROAD,	١
COLOMBO - 05	١

	DESIGNER
-	DESIGN UNIT
	NATIONAL BUILDING RESEARCH ORGANIZATION
	No. 99/1, JAWATTA ROAD,
	COLOMBO - 05

		REDUCTION OF LANDSLIDE
		VULNERABILITY BY MITIGATION MEASURES
		BOSCO COLLEGE - HATTON

REV DATE REVISION DESCRIPTION APPROVAL PROJECT TITLE

TITLE				DESCRIPTION	NAME	SIGNATURE	
				DRAWN	S.A.G.D. SENANAYAKA	Goige	
	DESIGN CROSS SE	CTION		DESIGNER	D.M.D.T. DASANAYAKA	Southy	
				CHECKED	B.I. KUMARAGE	Junta	
				RECOMMENDED	Prof. S.A.S. KULATHILAKA	M	
SCALE	1:500	DATE	11.05.2022	RECOMMENDED	Prof. S.A.S. KULATHILAKA		
PROJECT / DRAWING No. REVISIO RLVMMP/WORKS/NCB/PHII/043-BO/DR-04b 00				APPROVED	K.N. BANDARA		
Wild Control of the C							

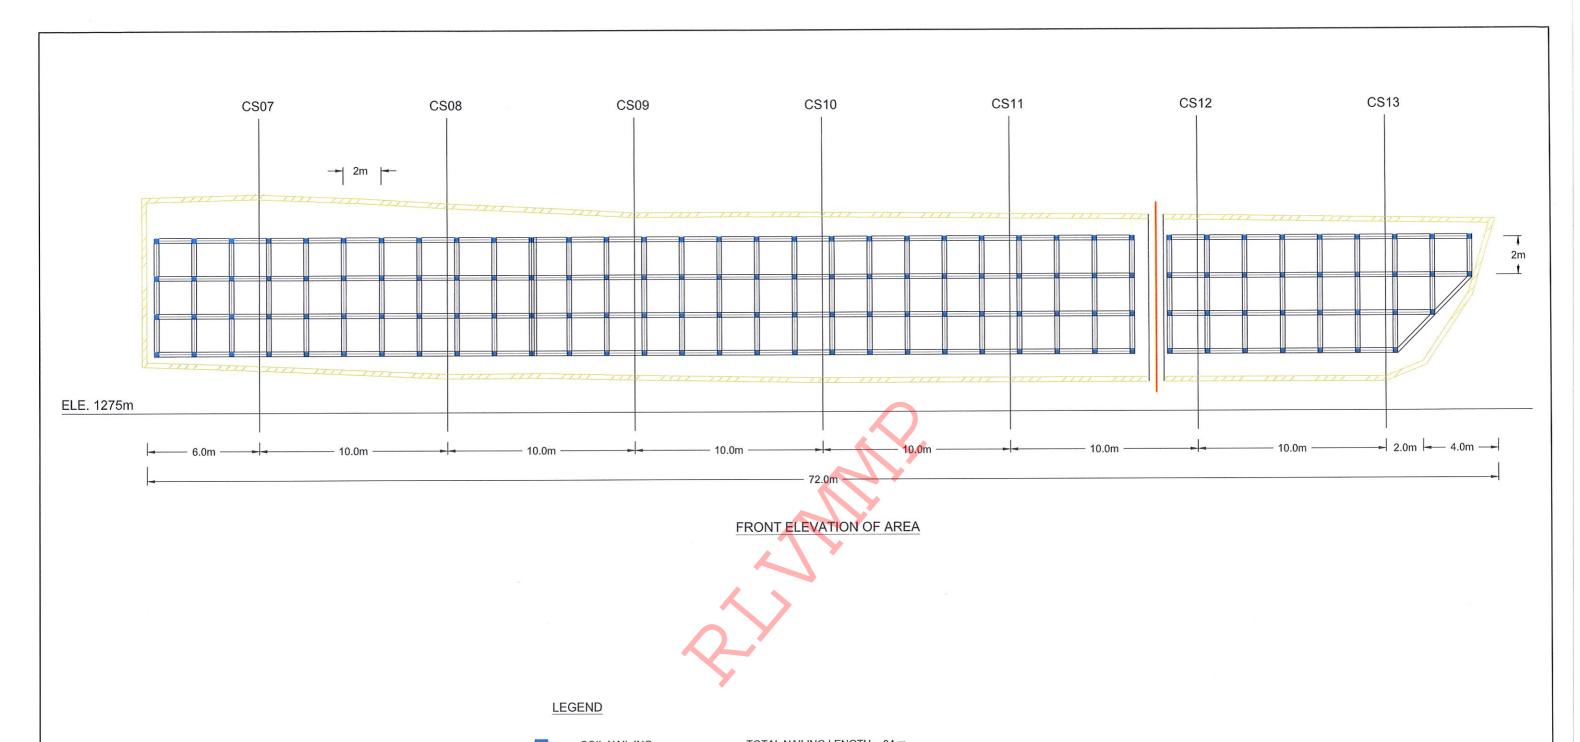

SOIL NAIL ING

TOTAL NAILING LENGTH = 04 m

NO'S OF NAILS = 141

REBAR DIAMETER = 32mm

DIAMETER OF THE BOREHOLE = 125mm

**BOUNDARY BEAM** 

REFURBISH EXISTING RRM DRAIN

#### NOTES


1. THE NUMBER OF NAILS, NAILS LENGTH AND NAIL LOCATION MAY BE VARIED ACCORDING TO THE ACTUAL SITE CONDITIONS.

EMPLOYER DEMOCRATIC SOCIALIST REPUBLIC OF SRI LANKA STATE MINISTRY OF NATIONAL SECURITY AND DISASTER MANAGEMENT NATIONAL BUILDING RESEARCH ORGANISATION No. 99/1, JAWATTA ROAD, COLOMBO - 05


DESIGNER **DESIGN UNIT** NATIONAL BUILDING RESEARCH ORGANIZATION No. 99/1, JAWATTA ROAD, COLOMBO - 05


REVISION DESCRIPTION | APPROVAL PROJECT TITLE REV DATE REDUCTION OF LANDSLIDE VULNERABILITY BY MITIGATION MEASURES BOSCO COLLEGE - HATTON


DESCRIPTION DRAWN S.A.G.D. SENANAYAKA FRONT ELEVATION DESIGNER D.M.D.T. DASANAYAKA CHECKED B.I. KUMARAGE DATE 11.05.2022 RECOMMENDED Prof. S.A.S. KULATHILAKA SCALE 1:750 PROJECT / DRAWING No. REVISION APPROVED K.N. BANDARA RLVMMP/WORKS/NCB/PHII/043-BO/DR-05

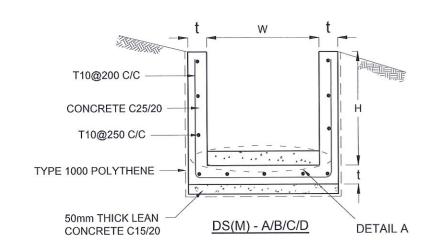


DRAIN TYPE	W (mm)	H (mm)	t (mm)
DS (M) - A /P	300	300	100
DS (M) - B/R	450	450	100
DS (M) - C/Q	600	600	100
DS (M) - D	750	750	125
DS (M) - E	900	900	150
DS (M) - F	1000	1000	150

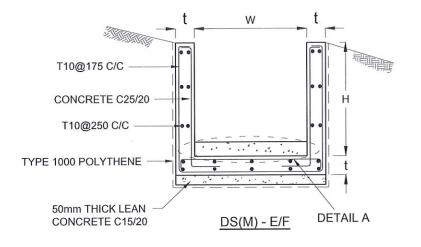

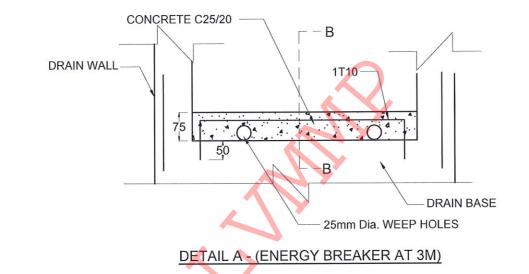

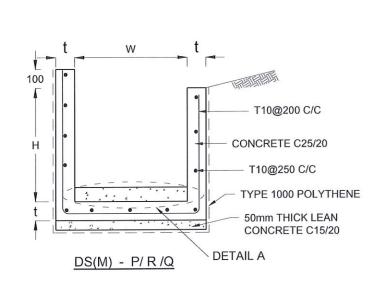

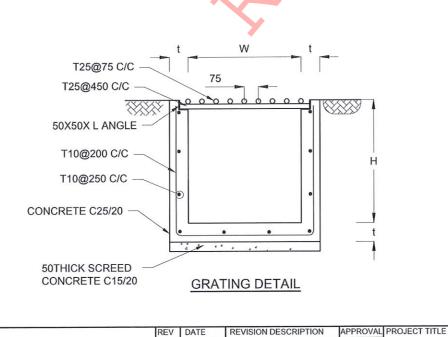

#### NOTES

- . DEPTH OF EXCAVATION MAY VARY ACCORDING TO SITE CONDITIONS
- STEPS SHALL BE CONSTRUCTED AT SURFACE DRAIN ON SLOPING GROUND ACCORDING TO THE SITE CONDITIONS AS INSTRUCTED BY THE ENGINEER.
- ENERGY BREAKERS SHALL BE CONSTRUCTED AT THE STEEP DRAIN SEGMENTS AS PER THE INSTRUCTIONS OF THE ENGINEER.
- 4. DOWELS SHALL BE INSTALLED ACCORDING TO THE GROUND CONDITIONS AS INSTRUCTED BY THE ENGINEER.
- 5. ALL DIMENSIONS ARE IN MILLIMETERS UNLESS OTHERWISE STATED.
- 6. 10 mm THICK EXPANSION JOINT SHALL BE INTRODUCED IN EVERY 5m INTERVAL.

#### CONCRETE

- 7. USE FOLLOWING CONCRETE GRADES FOR STRUCTURE
  - [a] SCREED C. 15/20
  - [b] WALLS / BASE / ENERGY BREAKERS C. 25/20

#### REINFORCEMENT

- ALL BARS MARKED "T" SHALL BE HIGH YIELD DEFORMED BARS OF YIELD STRENGTH NOT LESS THAN 460N/mm².
- . BARS OF CUT LENGTH LARGER THAN THE SUPPLIED LENGTH TO BE LAPPED FOR A LENGTH OF 50 x BAR DIA. AND LAPPING SHOULD BE STAGGERED.
- 10. ANCHORAGE LENGTH SHOULD BE 40X BAR DIA.
- REINFORCEMENT BARS SHALL BE BENT IN ACCORDANCE WITH STANDARD SPECIFICATIONS.
- COVER TO REINFORCEMENT
  - [a] BURIED FACES AND DRAIN INVERTS 40 mm
  - b] ALL OTHER FACES 25 mm

CONCRETE C 25/20

150

50X50 WELDED
GALVANIZED MESH

DETAILS OF BERM SEALING

10 mm THICK
JOINT SEALANT

10 mm THICK
POLYSTYRENE

EXPANTION JOINT DETAIL

DEMOCRATIC SOCIALIST REPUBLIC OF SRI LANKA

STATE MINISTRY OF NATIONAL SECURITY AND DISASTER MANAGEMENT
NATIONAL BUILDING RESEARCH ORGANISATION
No. 99/1, JAWATTA ROAD,
COLOMBO - 05


DESIGNER


DESIGN UNIT

NATIONAL BUILDING RESEARCH ORGANIZATION
No. 99/1, JAWATTA ROAD,
COLOMBO - 05

REDUCTION OF LANDSLIDE
VULNERABILITY BY MITIGATION MEASURES
BOSCO COLLEGE - HATTON

DESCRIPTION DRAWN S.A.G.D. SENANAYAKA DETAILS OF DRAINS DESIGNER (SURFACE DRAIN -1 OF 2) D.M.D.T. DASANAYAKA CHECKED B.I. KUMARAGE RECOMMENDE Prof. S.A.S. KULATHILAKA DATE 11.05.2022 REVISION APPROVED K.N. BANDARA RLVMMP/WORKS/NCB/PHII/043-BO/DR-06a

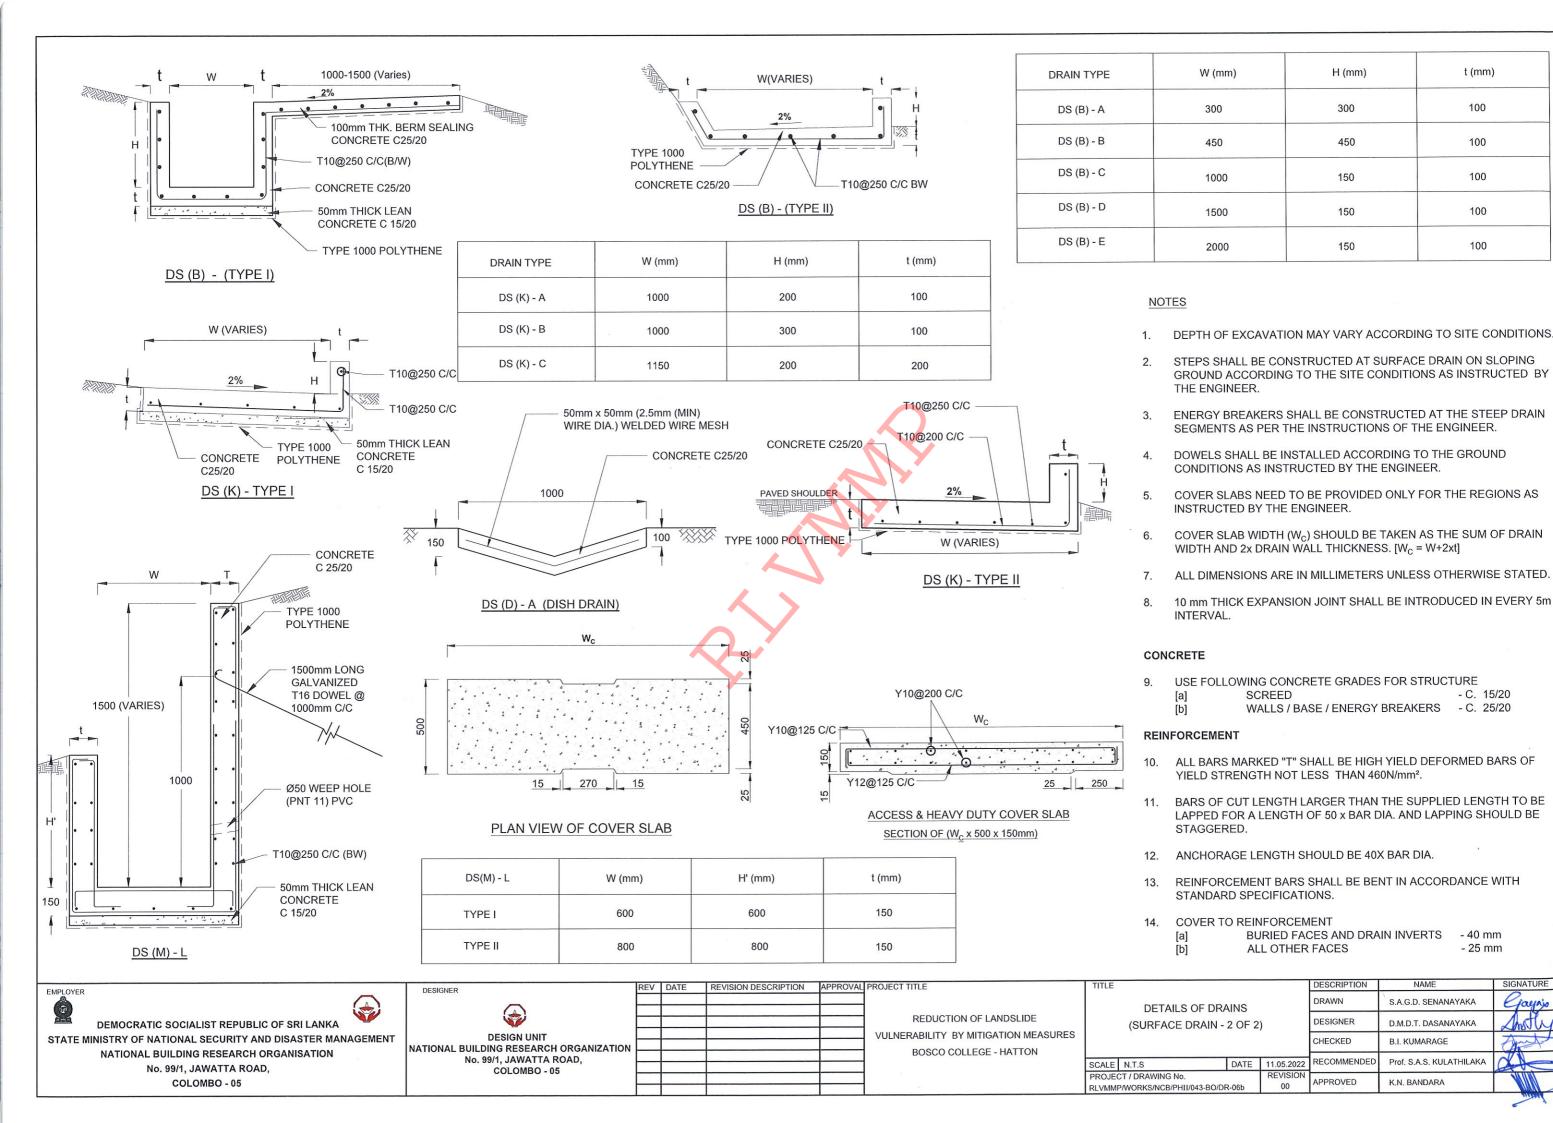

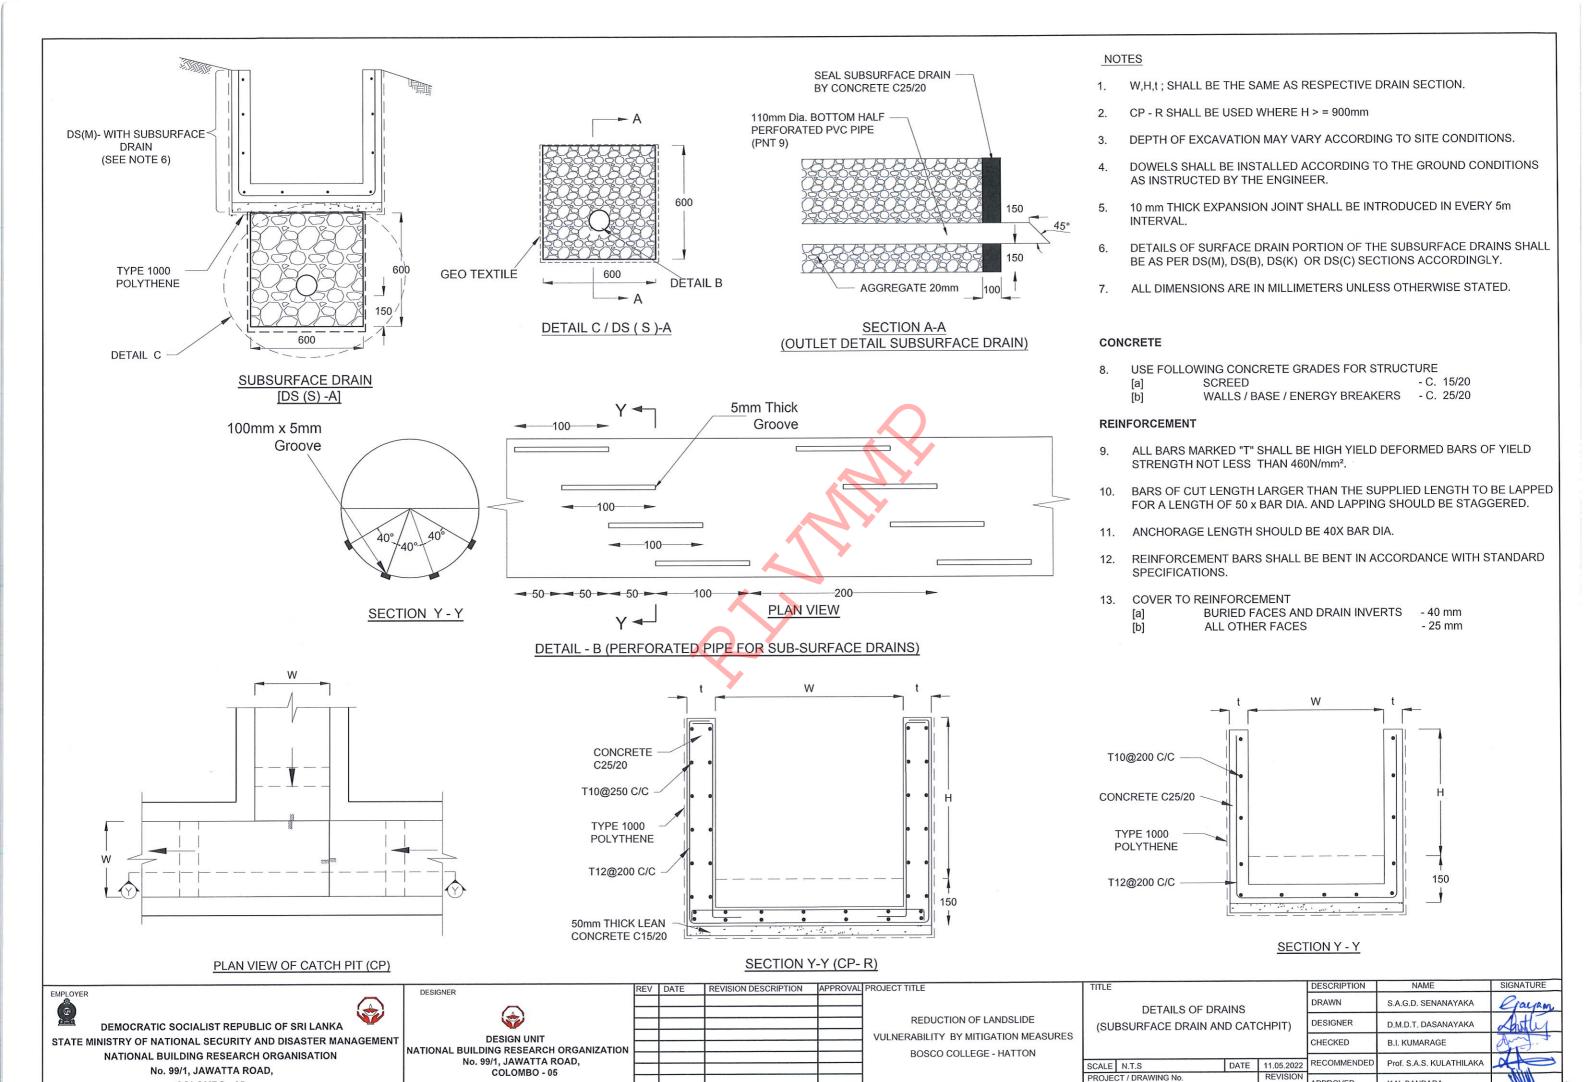



APPROVED


RLVMMP/WORKS/NCB/PHII/043-BO/DR-060

K.N. BANDARA

COLOMBO - 05

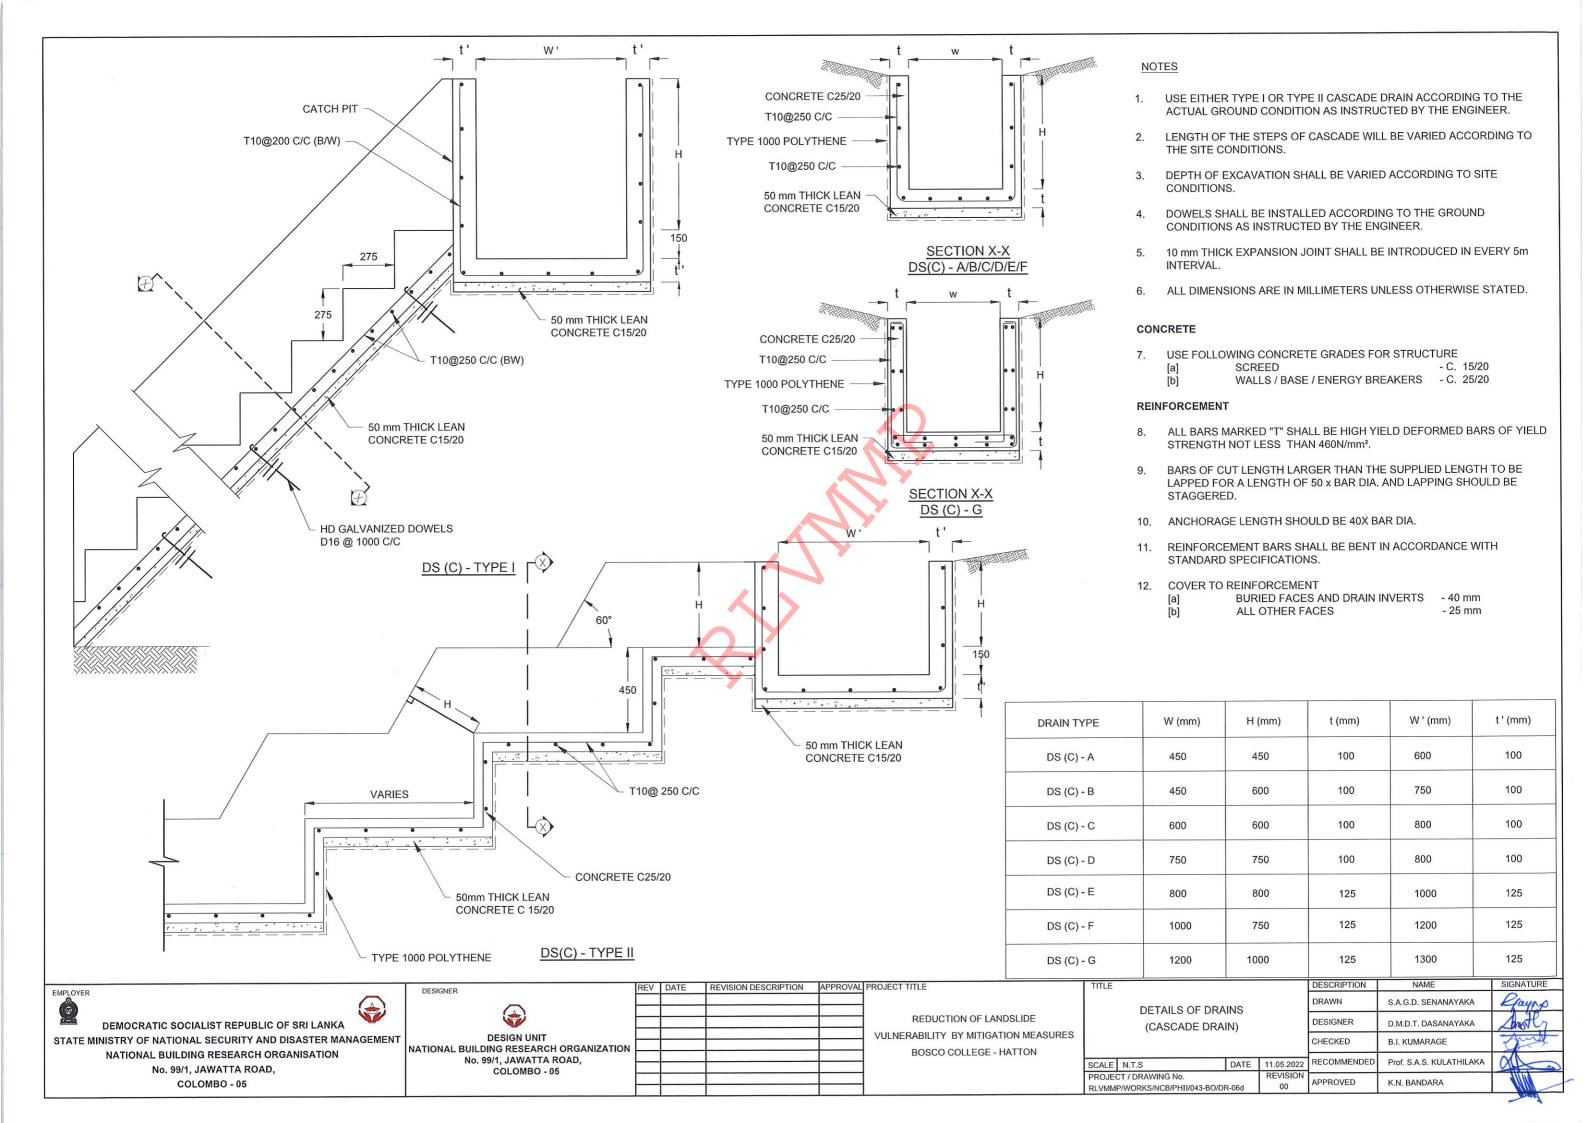

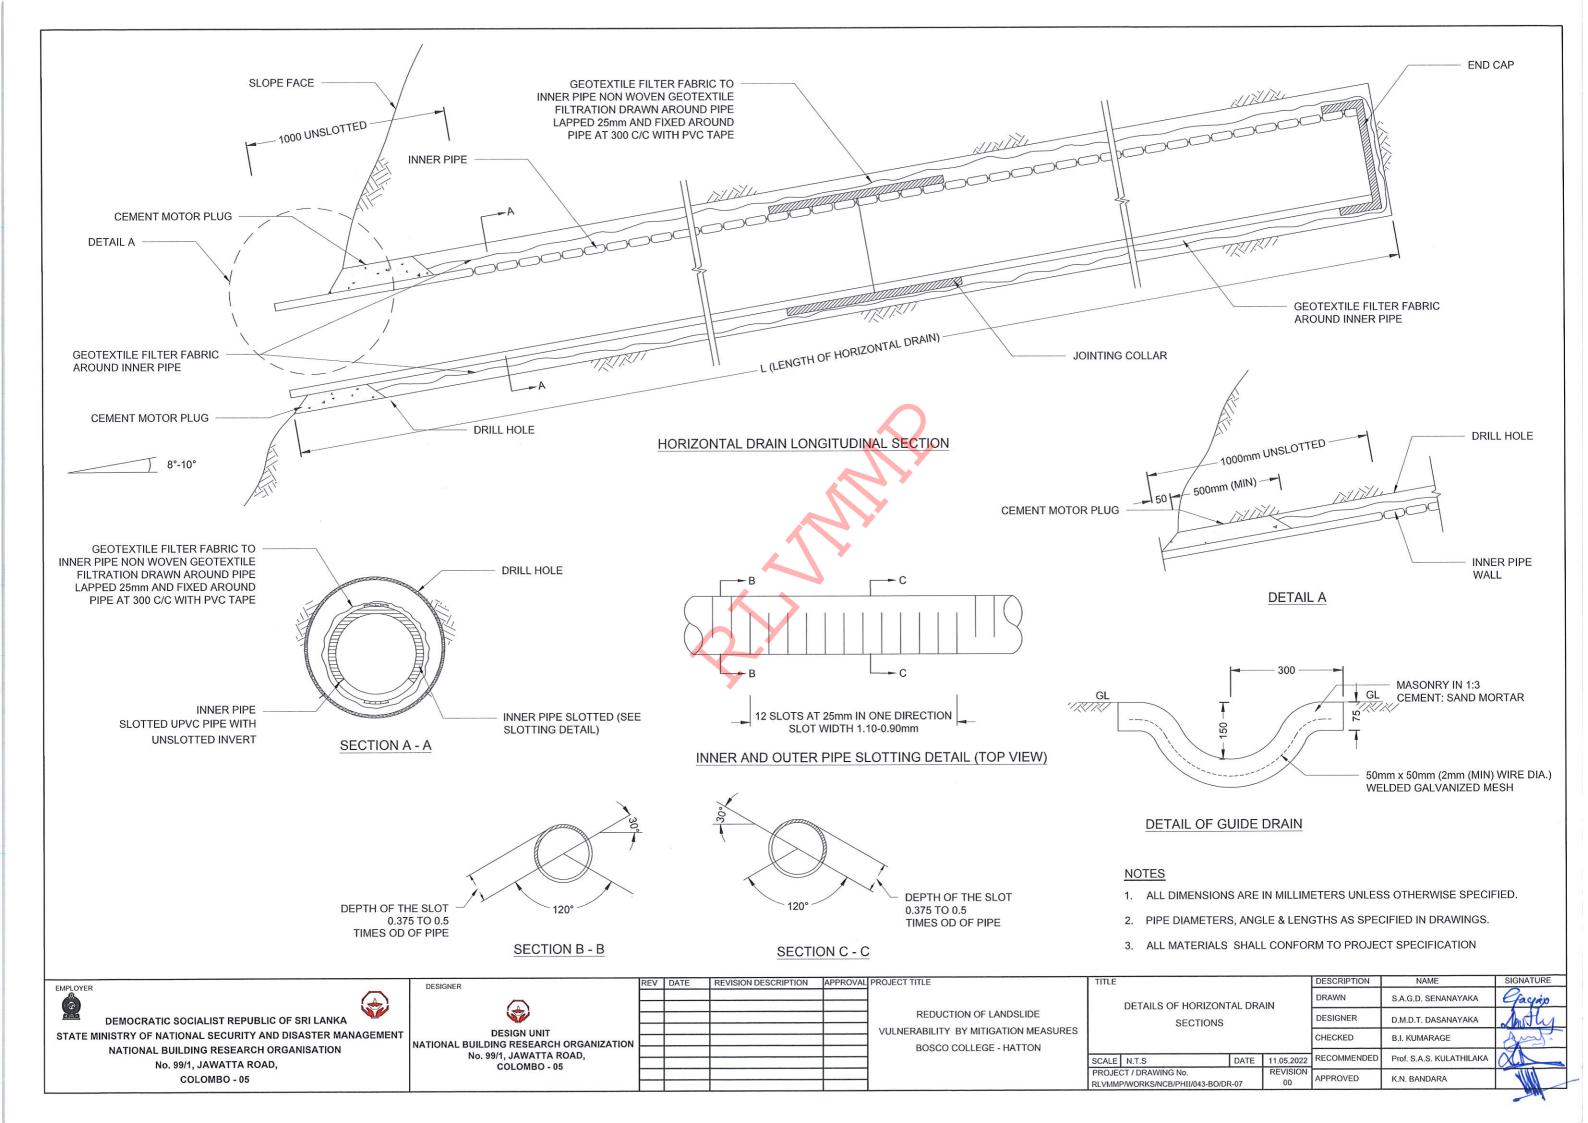


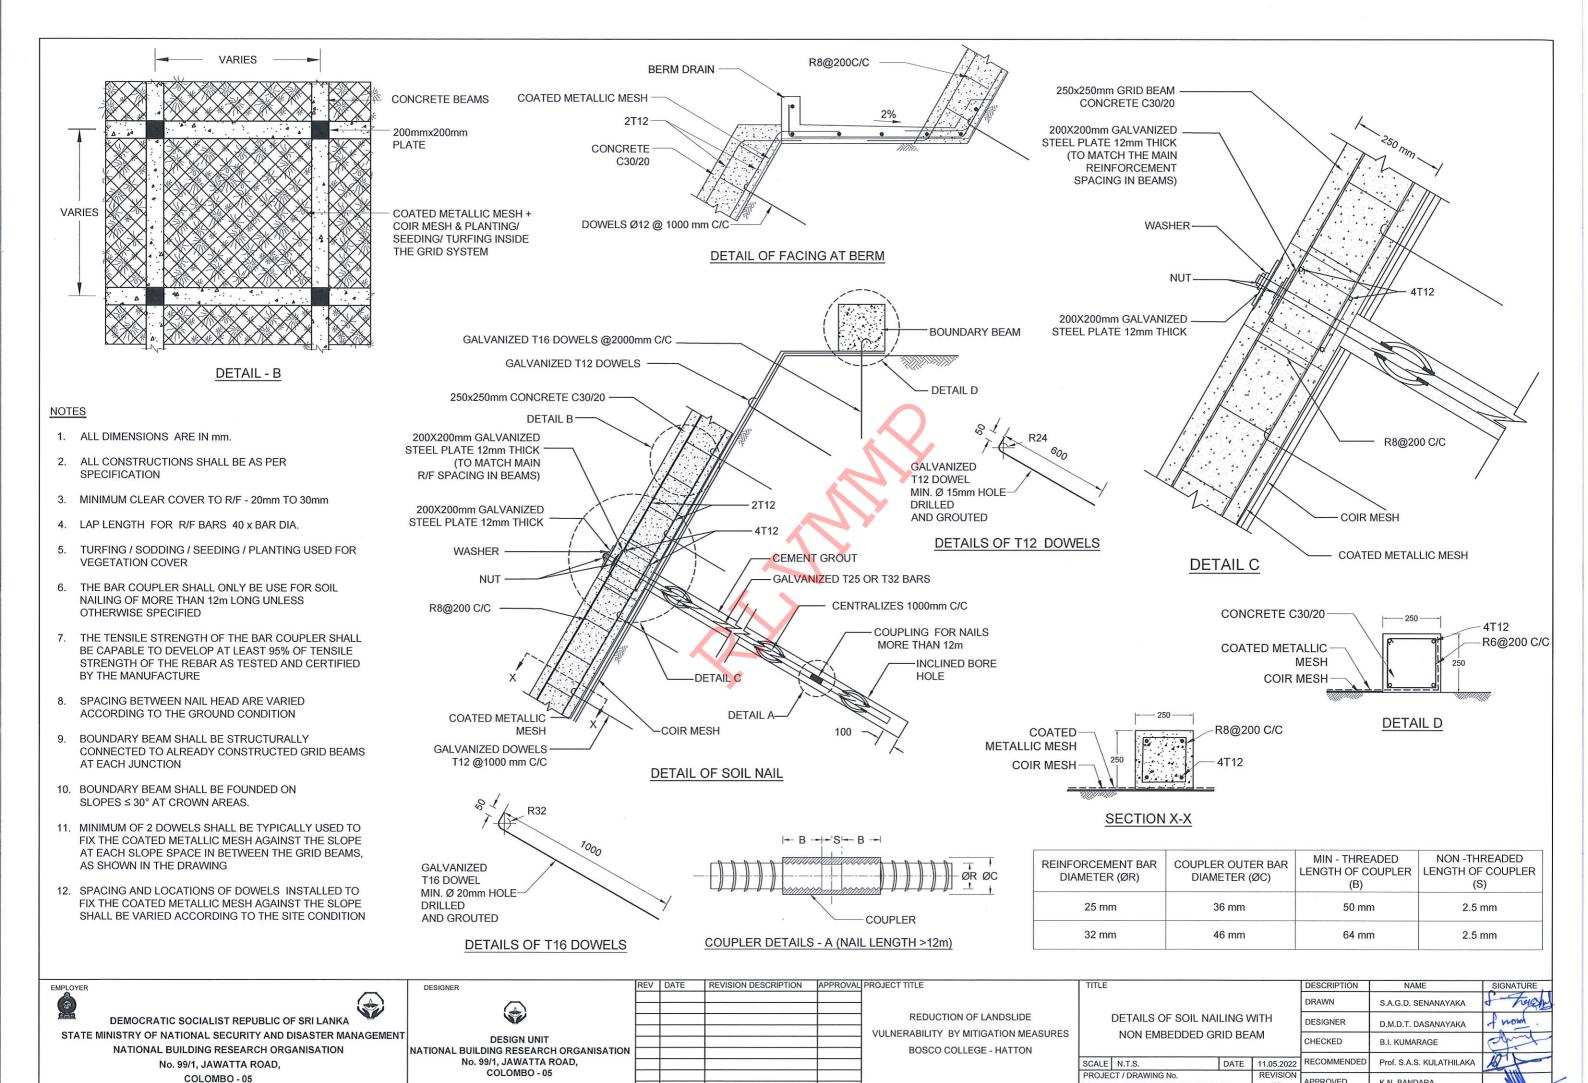


**APPROVED** 

RLVMMP/WORKS/NCB/PHII/043-BO/DR-08

K.N. BANDARA

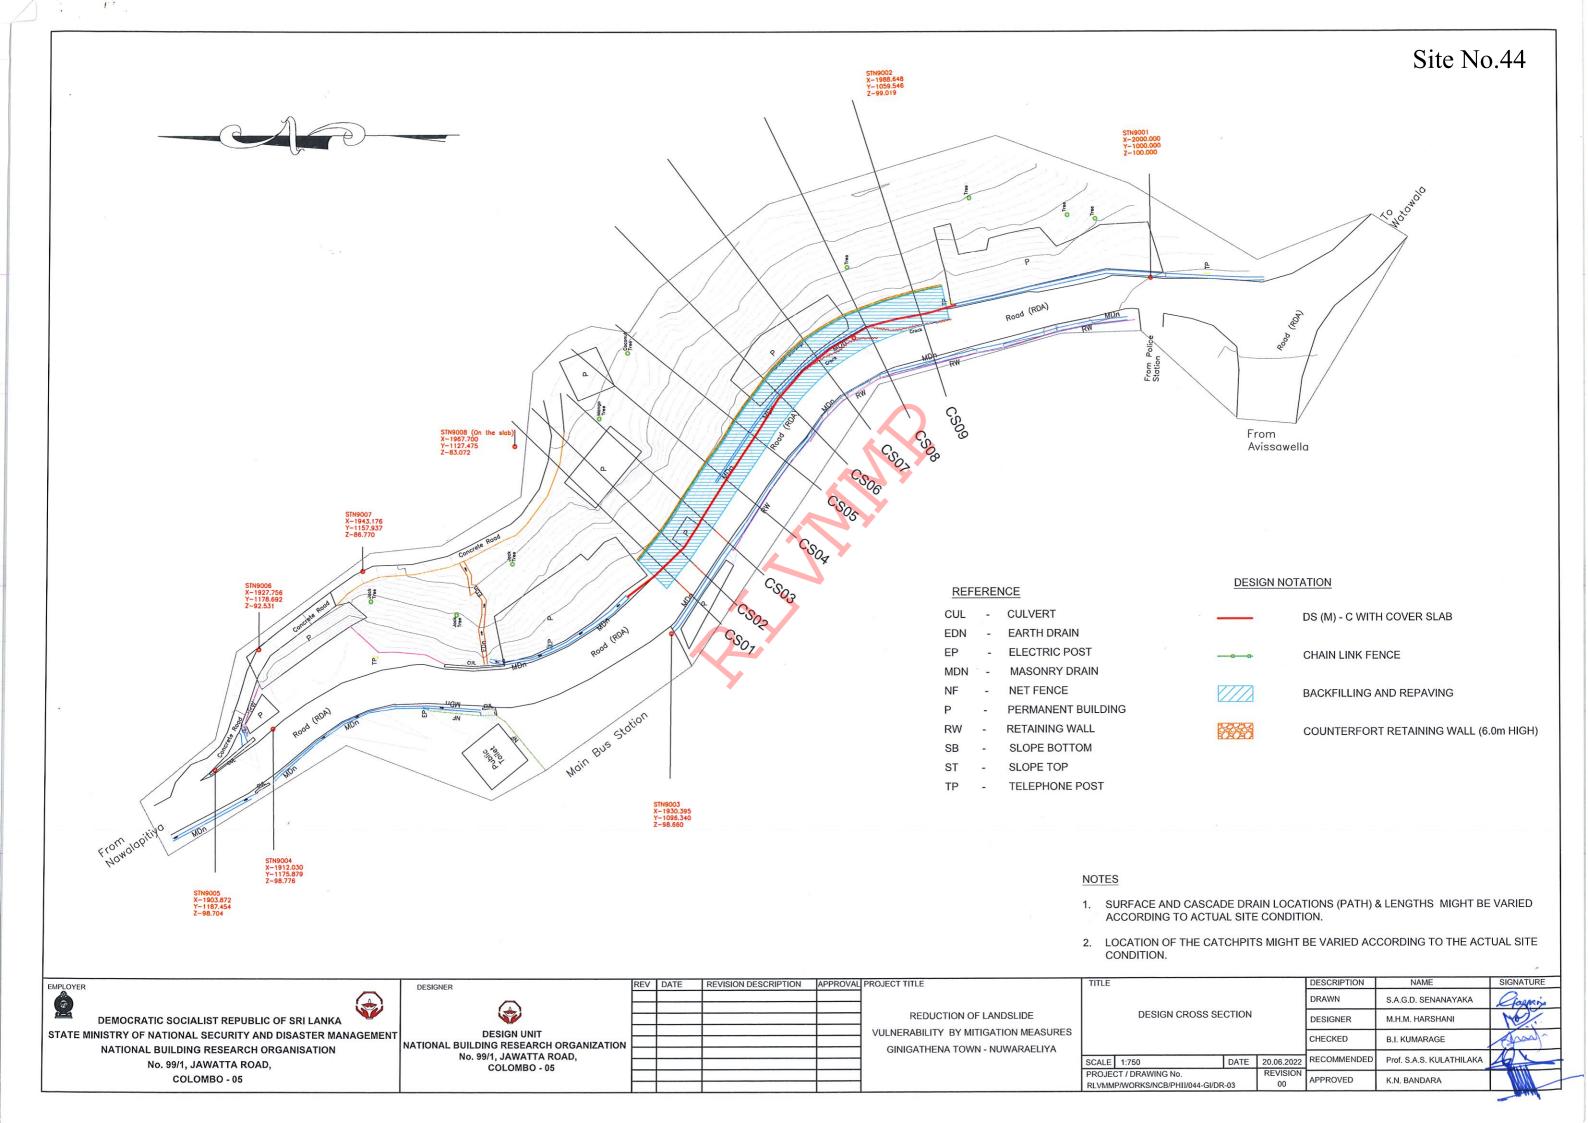

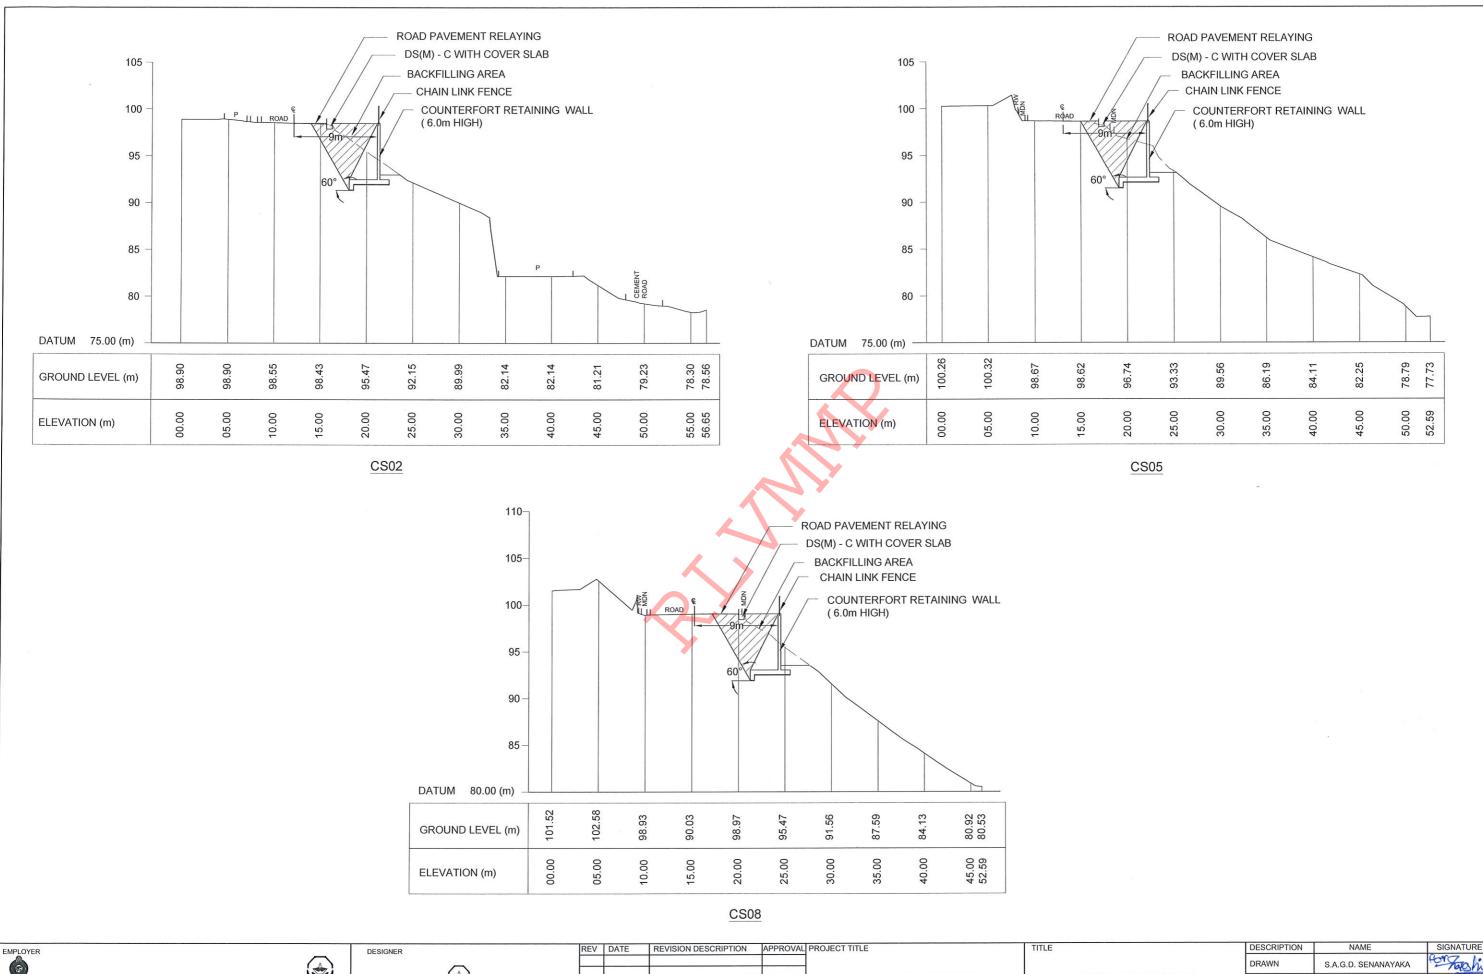


DEMOCRATIC SOCIALIST REPUBLIC OF SRI LANKA
STATE MINISTRY OF NATIONAL SECURITY AND DISASTER MANAGEMENT
NATIONAL BUILDING RESEARCH ORGANISATION
No. 99/1, JAWATTA ROAD,
COLOMBO - 05


DESIGN UNIT
NATIONAL BUILDING RESEARCH ORGANIZATION
No. 99/1, JAWATTA ROAD,
COLOMBO - 05


REDUCTION OF LANDSLIDE  VULNERABILITY BY MITIGATION MEASURES  GINIGATHENA TOWN - NUWARAELIYA

	IIILE			DESCRIPTION	NAME	SIGNATURE
				DRAWN	S.A.G.D. SENANAYAKA	Gor Fashil
	DESIGN CROSS SE	ECTION		DESIGNER	M.H.M. HARSHANI	1402
				CHECKED	B.I. KUMARAGE	and.
	SCALE   1:500   DATE   20.0			RECOMMENDED	Prof. S.A.S. KULATHILAKA	A
				APPROVED	K.N. BANDARA	

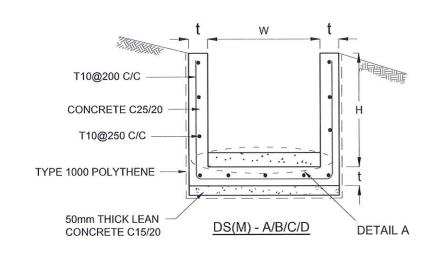



DRAIN TYPE	W (mm)	H (mm)	t (mm)	
DS (M) - A /P	300	300	100	
DS (M) - B/R	450	450	100	
DS (M) - C/Q	600	600	100	
DS (M) - D	750	750	125	
DS (M) - E	900	900	150	
DS (M) - F	1000	1000	150	

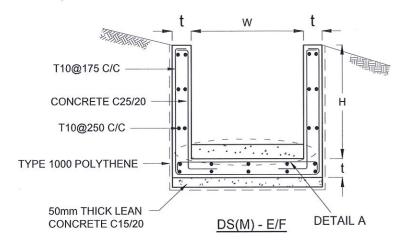

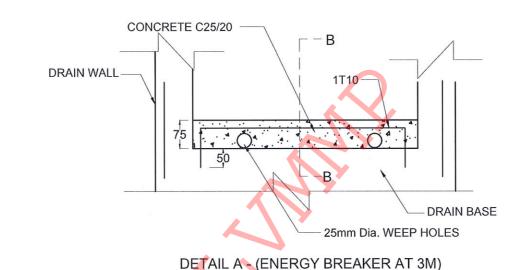

REVISION DESCRIPTION | APPROVAL PROJECT TITLE

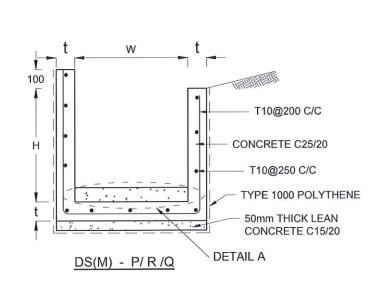

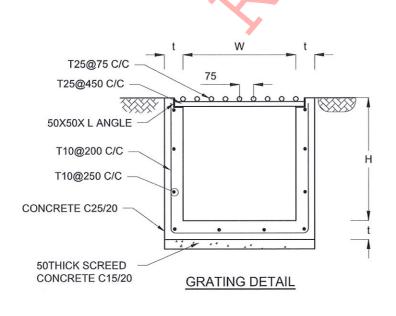

#### NOTES

- DEPTH OF EXCAVATION MAY VARY ACCORDING TO SITE CONDITIONS.
- STEPS SHALL BE CONSTRUCTED AT SURFACE DRAIN ON SLOPING GROUND ACCORDING TO THE SITE CONDITIONS AS INSTRUCTED BY THE ENGINEER.
- ENERGY BREAKERS SHALL BE CONSTRUCTED AT THE STEEP DRAIN SEGMENTS AS PER THE INSTRUCTIONS OF THE ENGINEER.
- 4. DOWELS SHALL BE INSTALLED ACCORDING TO THE GROUND CONDITIONS AS INSTRUCTED BY THE ENGINEER.
- 5. ALL DIMENSIONS ARE IN MILLIMETERS UNLESS OTHERWISE STATED.
- 10 mm THICK EXPANSION JOINT SHALL BE INTRODUCED IN EVERY 5m INTERVAL.

#### CONCRETE

- 7. USE FOLLOWING CONCRETE GRADES FOR STRUCTURE
  - [a] SCREED C. 15/20
  - [b] WALLS / BASE / ENERGY BREAKERS C. 25/20

#### REINFORCEMENT

- ALL BARS MARKED "T" SHALL BE HIGH YIELD DEFORMED BARS OF YIELD STRENGTH NOT LESS THAN 460N/mm².
- BARS OF CUT LENGTH LARGER THAN THE SUPPLIED LENGTH TO BE LAPPED FOR A LENGTH OF 50 x BAR DIA. AND LAPPING SHOULD BE STAGGERED.
- 10. ANCHORAGE LENGTH SHOULD BE 40X BAR DIA.
- 11. REINFORCEMENT BARS SHALL BE BENT IN ACCORDANCE WITH STANDARD SPECIFICATIONS.
- COVER TO REINFORCEMENT
  - [a] BURIED FACES AND DRAIN INVERTS 40 mm
  - [b] ALL OTHER FACES 25 mm

CONCRETE C 25/20

150

DETAILS OF BERM SEALING

10 mm THICK
JOINT SEALANT
10 mm THICK
POLYSTYRENE

EXPANTION JOINT DETAIL

DEMOCRATIC SOCIALIST REPUBLIC OF SRI LANKA
STATE MINISTRY OF NATIONAL SECURITY AND DISASTER MANAGEMENT
NATIONAL BUILDING RESEARCH ORGANISATION
No. 99/1, JAWATTA ROAD,
COLOMBO - 05

EMPLOYER


DESIGNER


DESIGN UNIT


NATIONAL BUILDING RESEARCH ORGANIZATION
No. 99/1, JAWATTA ROAD,
COLOMBO - 05


REDUCTION OF LANDSLIDE
VULNERABILITY BY MITIGATION MEASURES
GINIGATHENA TOWN - NUWARAELIYA

DESCRIPTION SIGNATURE DRAWN S.A.G.D. SENANAYAKA DETAILS OF DRAINS DESIGNER M.H.M. HARSHANI (SURFACE DRAIN -1 OF 2) CHECKED B.I. KUMARAGE RECOMMENDE Prof. S.A.S. KULATHILAKA SCALE N.T.S DATE 20.06.2022 APPROVED K.N. BANDARA RLVMMP/WORKS/NCB/PHII/044-GI/DR-05a

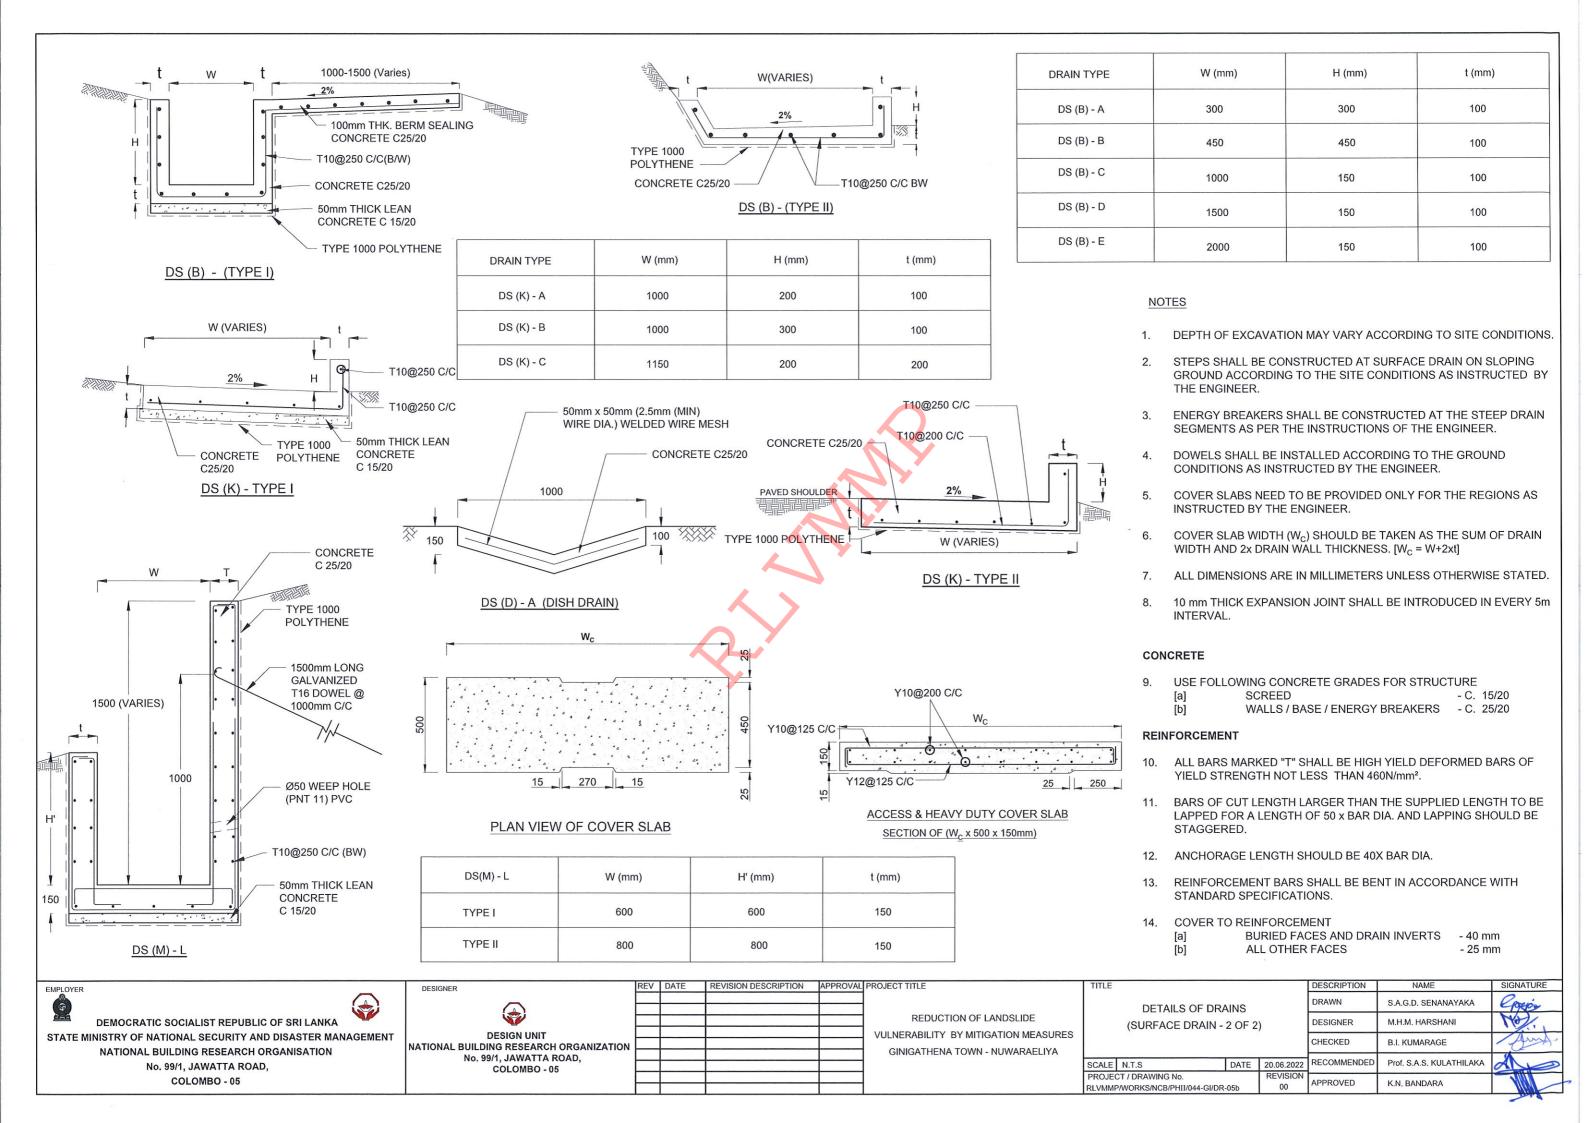

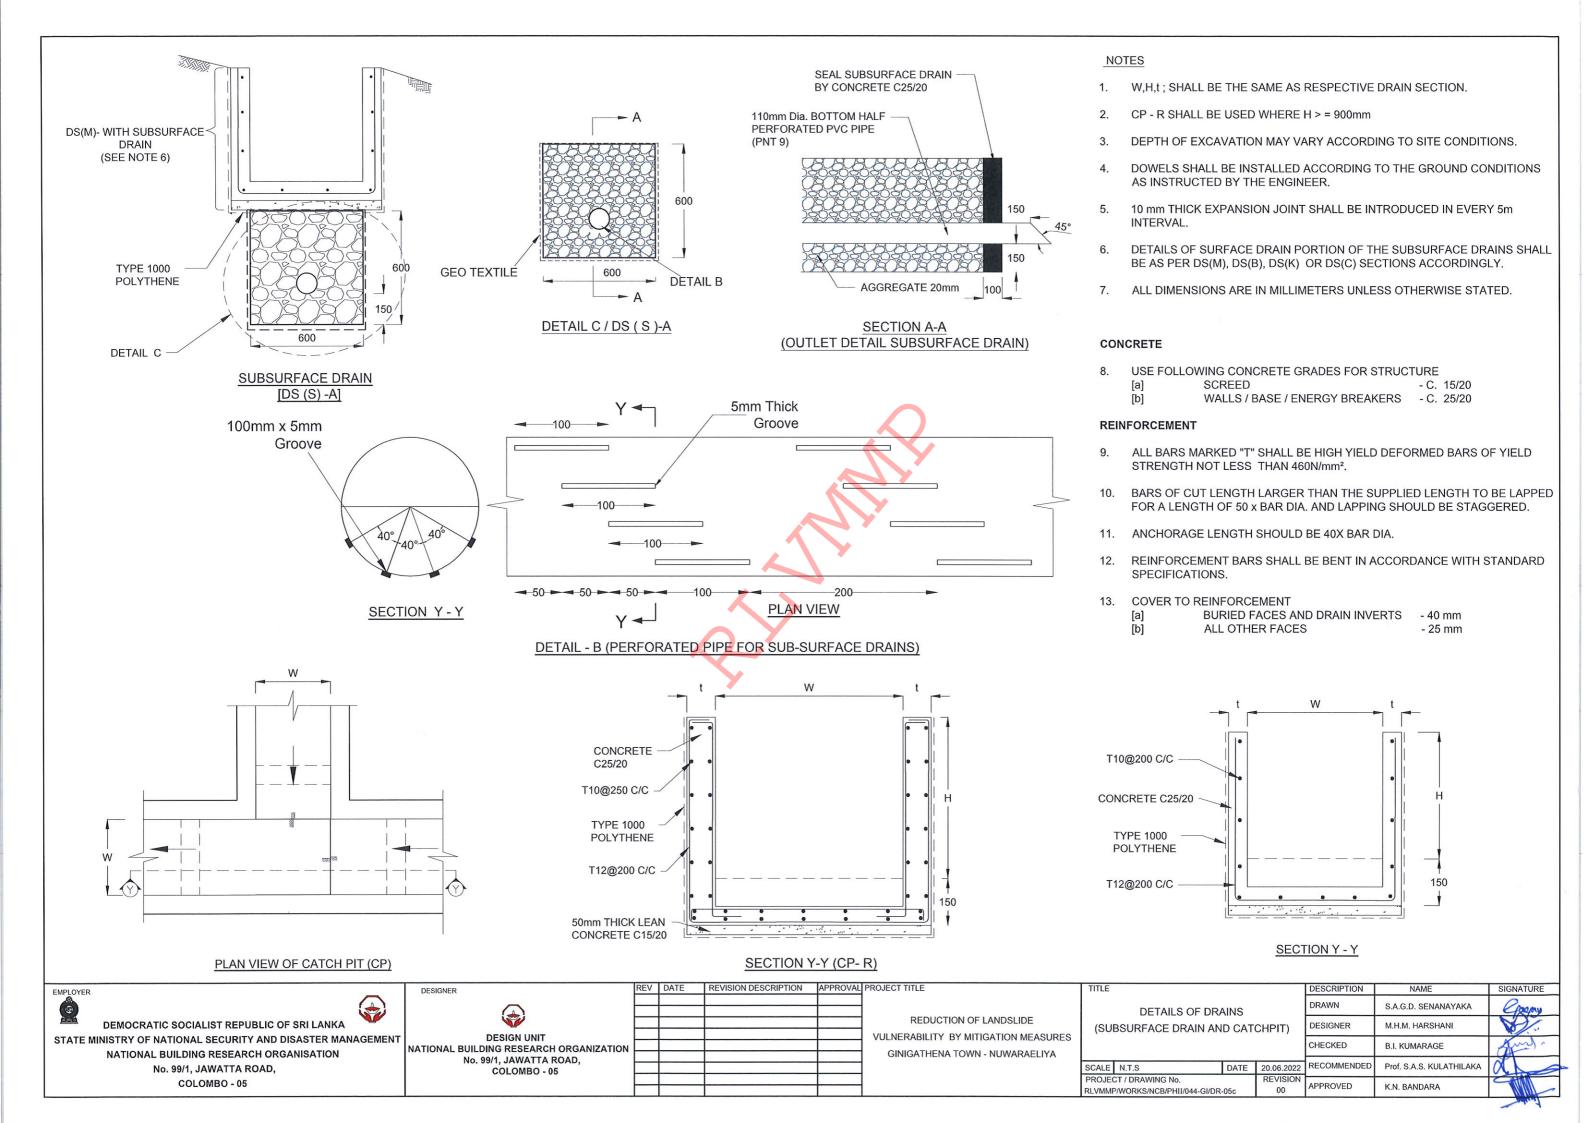

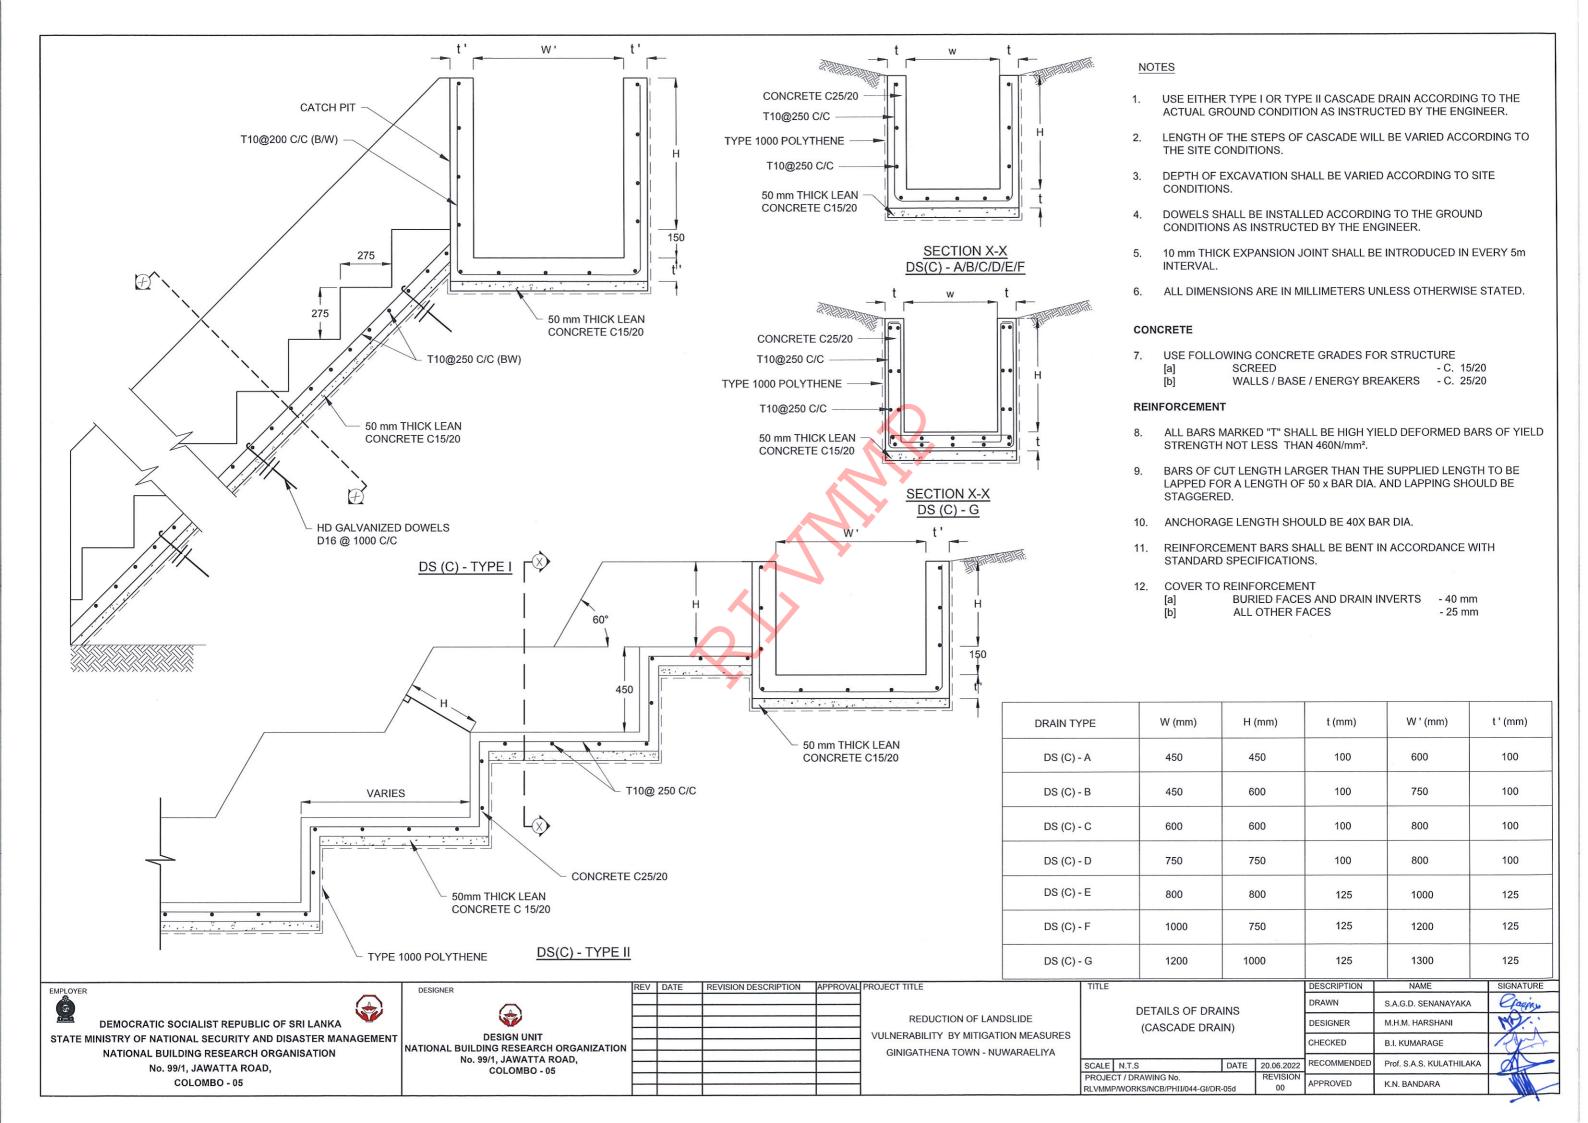

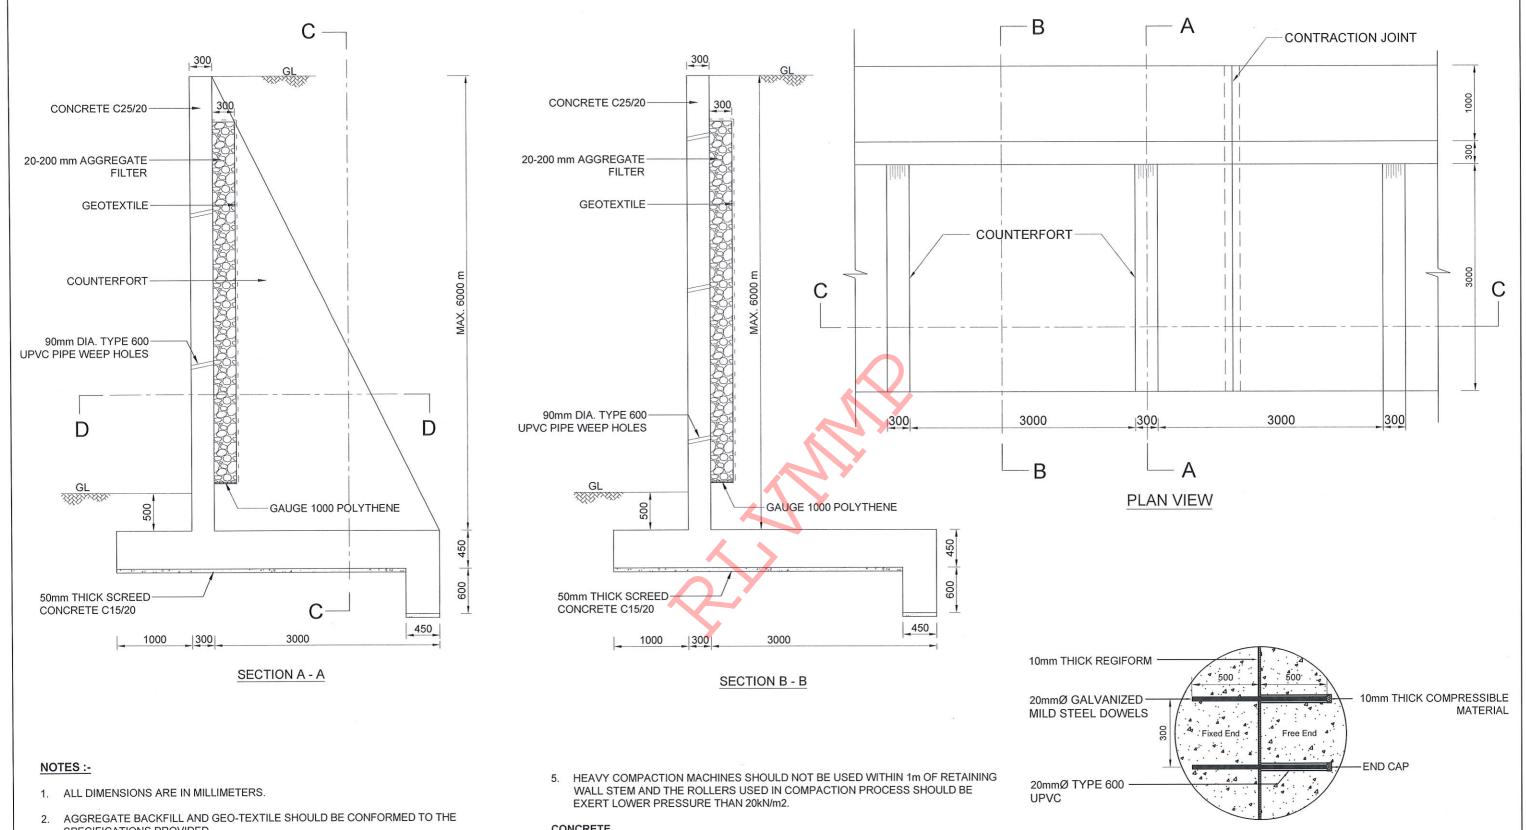


- SPECIFICATIONS PROVIDED.
- 3. 90mm DIAMETER WEEP HOLES SHOULD BE PROVIDED IN 1m VERTICAL AND 1.5m HORIZONTAL SPACING AND SHOULD BE STAGGERED.
- 4. R16, 1000mm LONG DOWELS SHOULD BE PROVIDED AT 1000mm SPACING IN LONGITUDINAL DIRECTION AND AT 600mm SPACING IN TRANSVERSE DIRECTION IF ROCK SURFACE FOUND.

#### CONCRETE

- 6. USE FOLLOWING CONCRETE GRADES FOR STRUCTURE
  - [a] SCREED
- GR. 15/20
- GR. 25/20 [b] WALLS / BASE

**DETAILS OF CONTRACTION JOINT** (Not to Scale)

DESCRIPTION NAME SIGNATURE REVISION DESCRIPTION | APPROVAL PROJECT TITLE REV DATE DESIGNER EMPLOYER S.A.G.D.SENANAYAKA REDUCTION OF LANDSLIDE DETAILS OF COUNTERFORT RETAINING WALL DESIGNED M.H.M. HARSHAN DEMOCRATIC SOCIALIST REPUBLIC OF SRI LANKA VULNERABILITY BY MITIGATION MEASURES **DESIGN UNIT** STATE MINISTRY OF NATIONAL SECURITY AND DISASTER MANAGEMENT B.I. KUMARAGE CHECKED NATIONAL BUILDING RESEARCH ORGANISATION GINIGATHENA TOWN - NUWARAELIYA NATIONAL BUILDING RESEARCH ORGANISATION No. 99/1, JAWATTA ROAD, DATE 20.06.2022 RECOMMENDED Prof.S.A.S.KULATHILAKA SCALE N.T.S No. 99/1, JAWATTA ROAD, COLOMBO - 05 PROJECT / DRAWING No. REVISION COLOMBO - 05 APPROVED K.N.BANDARA RLVMMP/WORKS/NCB/PHII/044-GI/DR-06a

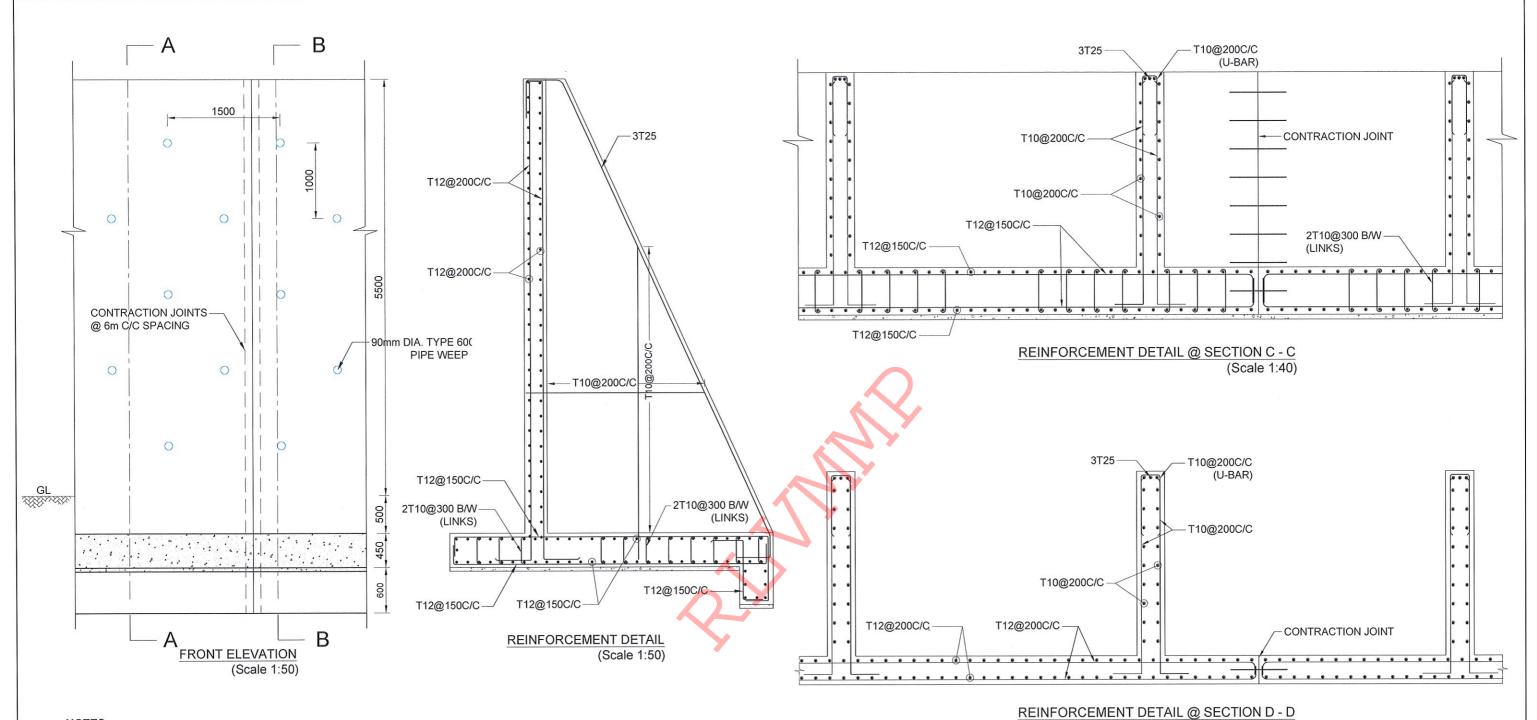

#### NOTES :-

- 1. ALL DIMENSIONS ARE IN MILLIMETERS.
- AGGREGATE BACKFILL AND GEO-TEXTILE SHOULD BE CONFORMED TO THE SPECIFICATIONS PROVIDED.
- 90mm DIAMETER WEEP HOLES SHOULD BE PROVIDED IN 1m VERTICAL AND 1.5m HORIZONTAL SPACING AND SHOULD BE STAGGERED.
- R16, 1000mm LONG DOWELS SHOULD BE PROVIDED AT 1000mm SPACING IN LONGITUDINAL DIRECTION AND AT 600mm SPACING IN TRANSVERSE DIRECTION IF ROCK SURFACE FOUND.
- HEAVY COMPACTION MACHINES SHOULD NOT BE USED WITHIN 1m OF RETAINING WALL STEM AND THE ROLLERS USED IN COMPACTION PROCESS SHOULD BE EXERT LOWER PRESSURE THAN 20kN/m2.

DESIGNER

#### CONCRETE

6. USE FOLLOWING CONCRETE GRADES FOR STRUCTURE

[a] SCREED

- GR. 15/20

[b] WALLS / BASE - GR. 25/20

#### REINFORCEMENT

REV DATE

 ALL BARS MARKED "T" SHALL BE HIGH YIELD DEFORMED BARS OF YIELD STRENGTH NOT LESS THAN 460N/mm².

REVISION DESCRIPTION | APPROVAL PROJECT TITLE

S. TENSION LAP LENGTH SHOULD BE 52 x BAR DIA. AND COMPRESSION LAP LENGTH SHOULD BE 38 x BAR DIA. LAPPING SHOULD BE STAGGERED. ANCHORAGE LENGTH SHOULD BE 40X BAR DIA.

Scale (1:40)

- REINFORCEMENT BARS SHALL BE BENT ACCORDANCE WITH STANDARD SPECIFICATIONS.
- CLEAR CONCRETE COVER FOR THE REINFORCEMENT ABOVE AND BELOW THE GROUND LEVEL SHALL BE 40mm AND 50 mm RESPECTIVELY.
- 11. 10mm THICK CONTRACTION JOINT SHALL BE INTRODUCED IN EVERY 6m INTERVALS AND SHALL BE PLACED AT ONE THIRD DISTANCE OF SPAN LENGTH BETWEEN TWO COUNTERFORTS.

DEMOCRATIC SOCIALIST REPUBLIC OF SRI LANKA

STATE MINISTRY OF NATIONAL SECURITY AND DISASTER MANAGEMENT
NATIONAL BUILDING RESEARCH ORGANISATION
No. 99/1, JAWATTA ROAD,
COLOMBO - 05


DESIGN UNIT
NATIONAL BUILDING RESEARCH ORGANISATION
No. 99/1, JAWATTA ROAD,
COLOMBO - 05


REDUCTION OF LANDSLIDE

VULNERABILITY BY MITIGATION MEASURES

GINIGATHENA TOWN - NUWARAELIYA

DESCRIPTION SIGNATURE DRAWN S.A.G.D.SENANAYAKA DETAILS OF COUNTERFORT RETAINING WALL DESIGNED M.H.M. HARSHANI B.I. KUMARAGE CHECKED RECOMMENDED Prof.S.A.S.KULATHILAKA SCALE N.T.S DATE 20.06,2022 PROJECT / DRAWING No. REVISION APPROVED K.N.BANDARA RLVMMP/WORKS/NCB/PHII/044-GI/DR-06b

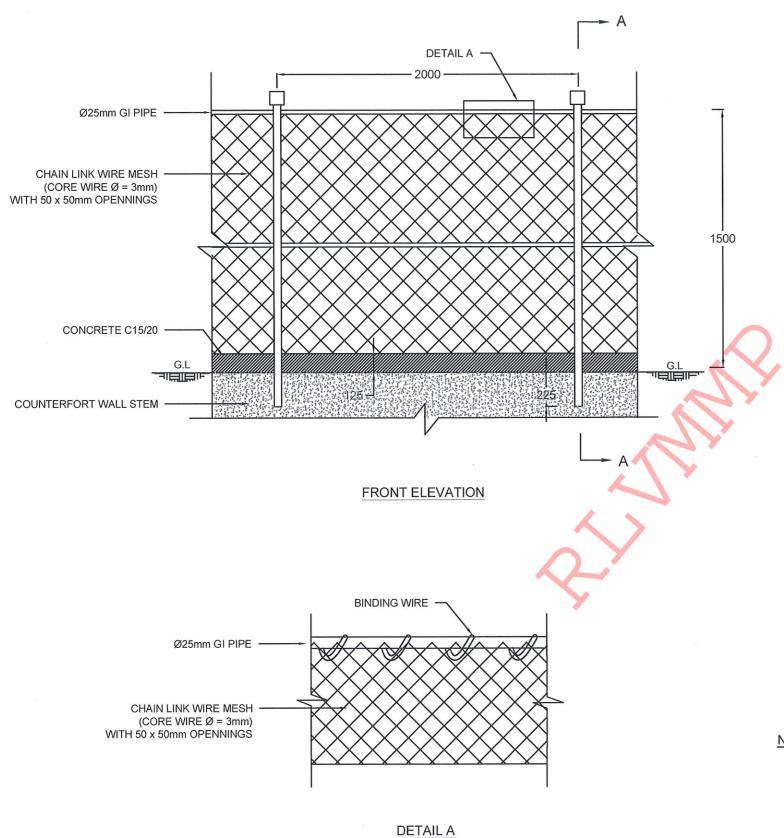

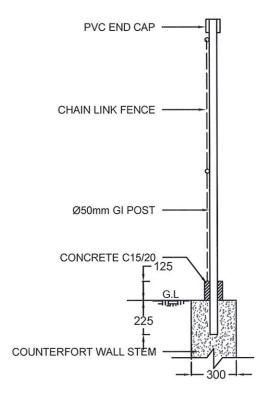

## **NOTES**

- 1. ALL DIMENSIONS ARE IN MILLIMETERS
- 2. GI POST SHOULD BE COVERED WITH GREEN COLOUR ANTI-CORROSIVE PAINT.
- 3. PRIOR APPROVAL IS REQUIRED FOR CHAIN LINK WIRE MESH, GI POST AND PVC CAP.

SECTION A - A

4. FENCE FOOTING TO BE CAST TOGETHER WITH COUNTERFORT WALL STEM.

DEMOCRATIC SOCIALIST REPUBLIC OF SRI LANKA
STATE MINISTRY OF INTERNAL SECURITY, HOME AFFAIRS
AND DISASTER MANAGEMENT
NATIONAL BUILDING RESEARCH ORGANIZATION
No. 99/1, JAWATTA ROAD,
COLOMBO - 05

EMPLOYER

DESIGNER

DESIGN UNIT

NATIONAL BUILDING RESEARCH ORGANIZATION

No. 99/1, JAWATTA ROAD,

COLOMBO - 05

REV DATE


REDUCTION OF LANDSLIDE

VULNERABILITY BY MITIGATION MEASURES

GINIGATHENA TOWN - NUWARAELIYA

REVISION DESCRIPTION APPROVAL PROJECT TITLE

NAME SIGNATURE DESCRIPTION S.A.G.D. SENANAYAKA DETAILS OF CHAIN LINK FENCE DESIGNED M.H.M. HARSHANI CHECKED B.I. KUMARAGE RECOMMENDE PROF. S.A.S. KULATHILAKA SCALE N.T.S. DATE 20.06.2022 PROJECT / DRAWING No. APPROVED K.N. BANDARA RLVMMP/WORKS/NCB/PHII/044-GI/DR-07

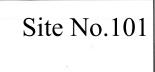

### **DESIGN NOTATION**

AMENDED GABION BOX

00000

LEANING TYPE RETAINING WALL

C------

DS (M) - Q

#### **NOTES**

- SURFACE DRAIN LOCATIONS (PATH OF THE DRAINS) & LENGTH MIGHT BE VARIED ACCORDING TO ACTUAL SITE CONDITION.
- LEANING TYPE RETAINING WALL HEIGHT SHALL BE VARIED ACCORDING TO THE SITE CONDITION AS INDICATED IN DESIGN CROSS SECTION.

DEMOCRATIC SOCIALIST REPUBLIC OF SRI LANKA
STATE MINISTRY OF NATIONAL SECURITY AND DISASTER MANAGEMENT
NATIONAL BUILDING RESEARCH ORGANISATION
No. 99/1, JAWATTA ROAD,
COLOMBO - 05

DESIGN UNIT
NATIONAL BUILDING RESEARCH ORGANIZATION
No. 99/1, JAWATTA ROAD,
COLOMBO - 05

REV DATE REVISION DESCRIPTION APPROVAL PROJECT TITLE


REDUCTION OF LANDSLIDE

VULNERABILITY BY MITIGATION MEASURES


SRI SADDHARMARAMAYA TEMPLE

THALAWAKELE

SIGNATURE DESCRIPTION NAME S.A.G.D. SENANAYAKA DESIGN PLAN VIEW V. G. D. GANGANI inom DESIGNER CHECKED B.I. KUMARAGE RECOMMENDE Prof. S.A.S. KULATHILAKA DATE 16.06.2022 APPROVED K.N. BANDARA RLVMMP/WORKS/NCB/PHII/101-TK/DR-03

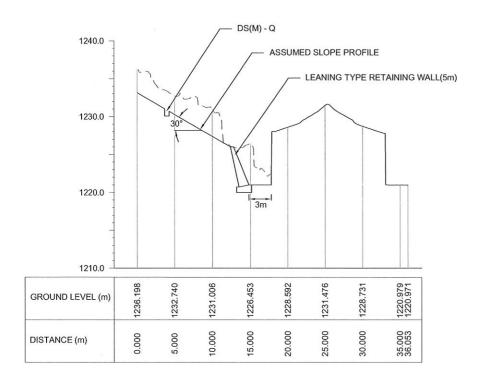


CS01

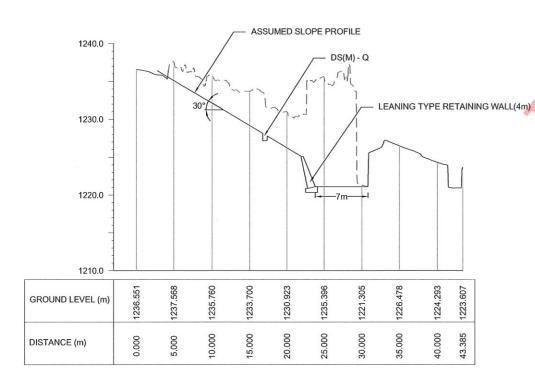


CS03

DESIGNER

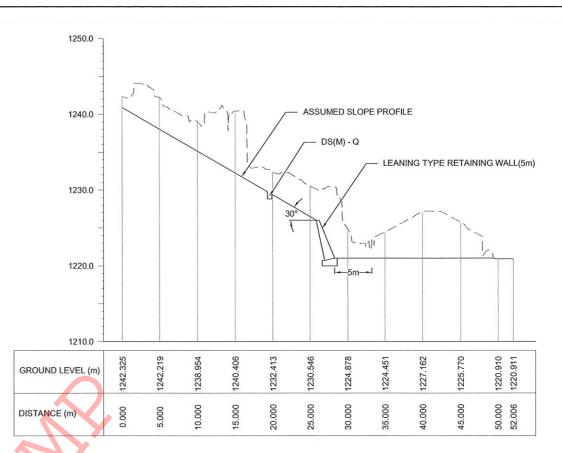

CS02

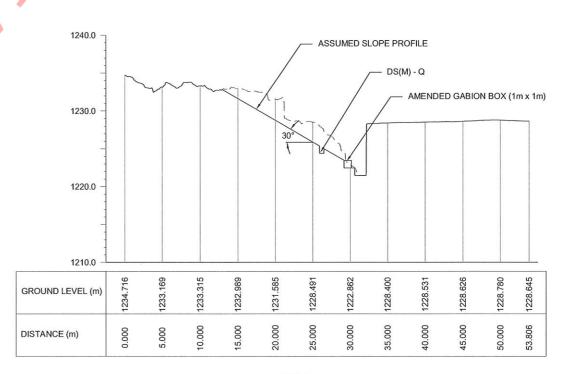

**CS04** 


DEMOCRATIC SOCIALIST REPUBLIC OF SRI LANKA STATE MINISTRY OF NATIONAL SECURITY AND DISASTER MANAGEMENT NATIONAL BUILDING RESEARCH ORGANISATION No. 99/1, JAWAS AT AT	N
COLOMBO - 05	l
	DEMOCRATIC SOCIALIST REPUBLIC OF SRI LANKA STATE MINISTRY OF NATIONAL SECURITY AND DISASTER MANAGEMENT NATIONAL BUILDING RESEARCH ORGANISATION No. 99/1, JAWATTA ROAD,

DESIGN UNIT
NATIONAL BUILDING RESEARCH ORGANIZATION
No. 99/1, JAWATTA ROAD,
COLOMBO - 05
525 (544) (545 - 544) (545)


$\overline{}$		 	 	
	_	 		REDUCTION OF LANDSLIDE
				VULNERABILITY BY MITIGATION MEASURES
IGN UNIT				VOLIVEINABILITY BY WITHOUTHOUT WILAGOINES
RESEARCH ORGANIZATION				SRI SADDHARMARAMAYA TEMPLE
JAWATTA ROAD.				THAT AMAZELE
LOMBO - 05				THALAWAKELE
LOMBO OF				


REV DATE REVISION DESCRIPTION APPROVAL PROJECT TITLE

	TITLE				DESCRIPTION	NAME	SIGNATURE
RES	DESIGN CROSS SECTION				DRAWN	S.A.G.D. SENANAYAKA	Gayans
					DESIGNER	V. G. D. GANGANI	nom!
					CHECKED	B.I. KUMARAGE	Sprant
	SCALE	1:500	DATE	16.06.2022	RECOMMENDED	Prof. S.A.S. KULATHILAKA	
	PROJECT / DRAWING No. REINTERPROJECT / DRAWING No. REINTERPROJECT / DRAWING No.			REVISION 00	APPROVED	K.N. BANDARA	1

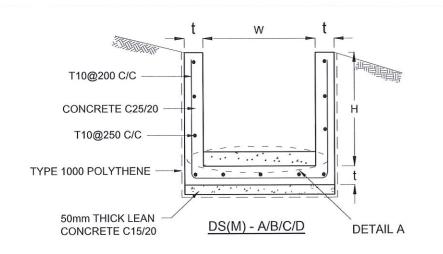



DRAIN TYPE	W (mm)	H (mm)	t (mm)	
DS (M) - A /P	300	300	100	
DS (M) - B/R	450	450	100	
DS (M) - C/Q	600	600	100	
DS (M) - D	750	750	125	
DS (M) - E	900	900	150	
DS (M) - F	1000	1000	150	

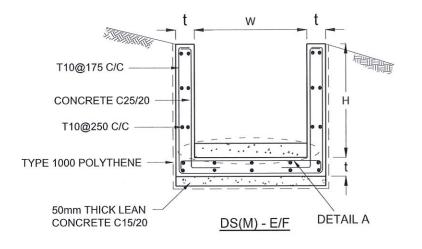

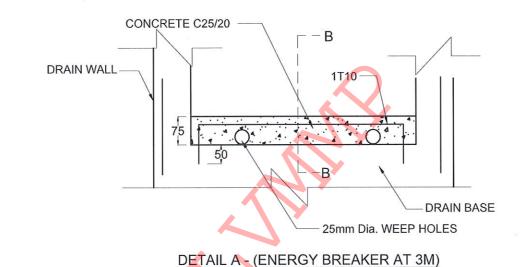

REVISION DESCRIPTION APPROVAL PROJECT TITLE

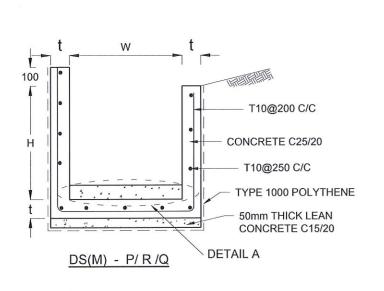

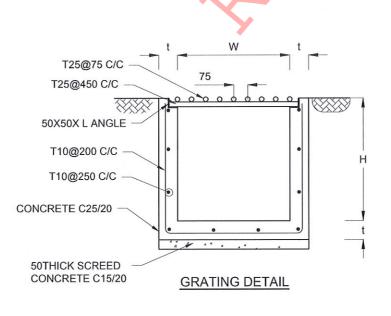

# **NOTES**

- DEPTH OF EXCAVATION MAY VARY ACCORDING TO SITE CONDITIONS.
- STEPS SHALL BE CONSTRUCTED AT SURFACE DRAIN ON SLOPING GROUND ACCORDING TO THE SITE CONDITIONS AS INSTRUCTED BY THE ENGINEER.
- ENERGY BREAKERS SHALL BE CONSTRUCTED AT THE STEEP DRAIN SEGMENTS AS PER THE INSTRUCTIONS OF THE ENGINEER.
- DOWELS SHALL BE INSTALLED ACCORDING TO THE GROUND CONDITIONS AS INSTRUCTED BY THE ENGINEER.
- ALL DIMENSIONS ARE IN MILLIMETERS UNLESS OTHERWISE STATED.
- 10 mm THICK EXPANSION JOINT SHALL BE INTRODUCED IN EVERY 5m INTERVAL.

#### CONCRETE

- 7. USE FOLLOWING CONCRETE GRADES FOR STRUCTURE
  - [a] SCREED - C. 15/20
  - WALLS / BASE / ENERGY BREAKERS C. 25/20 [b]

#### REINFORCEMENT

- ALL BARS MARKED "T" SHALL BE HIGH YIELD DEFORMED BARS OF YIELD STRENGTH NOT LESS THAN 460N/mm².
- BARS OF CUT LENGTH LARGER THAN THE SUPPLIED LENGTH TO BE LAPPED FOR A LENGTH OF 50 x BAR DIA. AND LAPPING SHOULD BE STAGGERED.
- ANCHORAGE LENGTH SHOULD BE 40X BAR DIA.
- REINFORCEMENT BARS SHALL BE BENT IN ACCORDANCE WITH STANDARD SPECIFICATIONS.
- 12. COVER TO REINFORCEMENT
  - BURIED FACES AND DRAIN INVERTS [a]
    - 40 mm ALL OTHER FACES - 25 mm

CONCRETE C 25/20 50X50 WELDED -50-**GALVANIZED MESH DETAILS OF BERM SEALING** 10 mm THICK JOINT SEALANT 10 mm THICK POLYSTYRENE 1Y10-**SECTION B-B EXPANTION JOINT DETAIL** 


DEMOCRATIC SOCIALIST REPUBLIC OF SRI LANKA STATE MINISTRY OF NATIONAL SECURITY AND DISASTER MANAGEMENT NATIONAL BUILDING RESEARCH ORGANISATION No. 99/1, JAWATTA ROAD, COLOMBO - 05


EMPLOYER


DESIGNER **DESIGN UNIT** NATIONAL BUILDING RESEARCH ORGANIZATION No. 99/1, JAWATTA ROAD, COLOMBO - 05

REDUCTION OF LANDSLIDE VULNERABILITY BY MITIGATION MEASURES SRI SADDHARMARAMAYA TEMPLE SCALE N.T.S. **THALAWAKELE** 

DESCRIPTION DRAWN S.A.G.D. SENANAYAKA DETAILS OF DRAINS DESIGNER V. G. D. GANGANI (SURFACE DRAIN -1 OF 2) CHECKED B.I. KUMARAGE RECOMMENDE Prof. S.A.S. KULATHILAKA DATE 16.06.2022 PROJECT / DRAWING No. APPROVED K.N. BANDARA RLVMMP/WORKS/NCB/PHII/101-TK/DR-05a

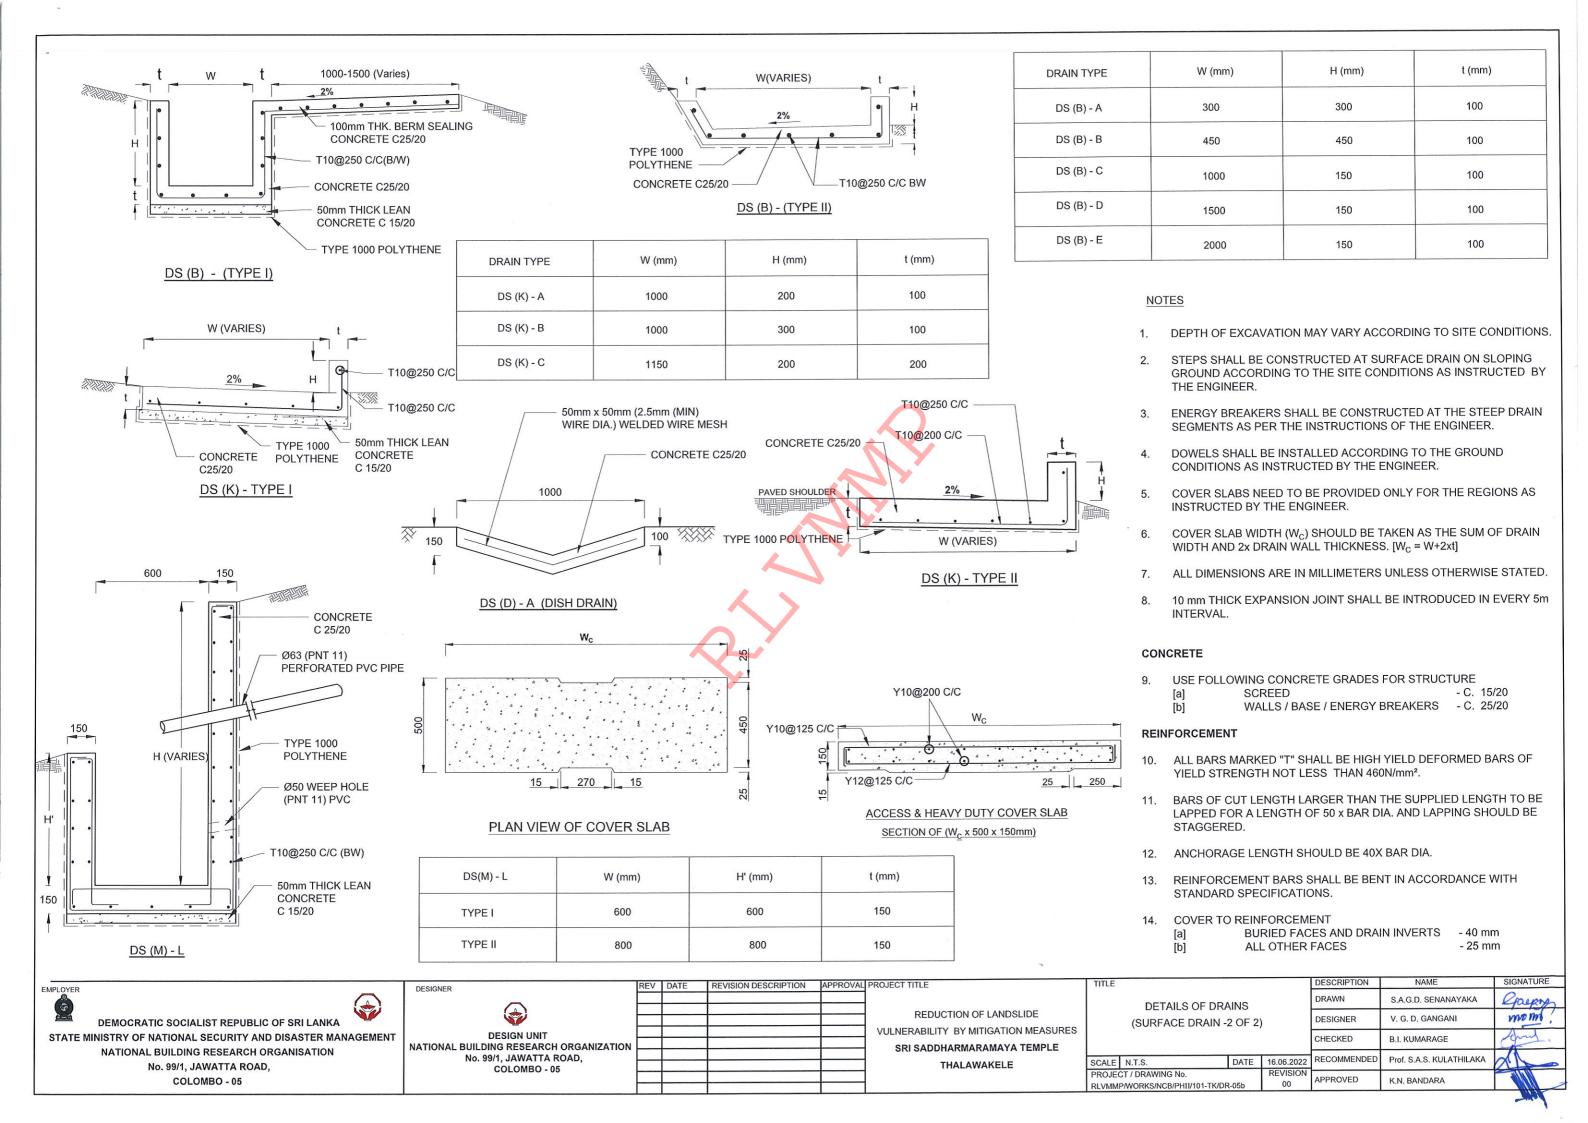

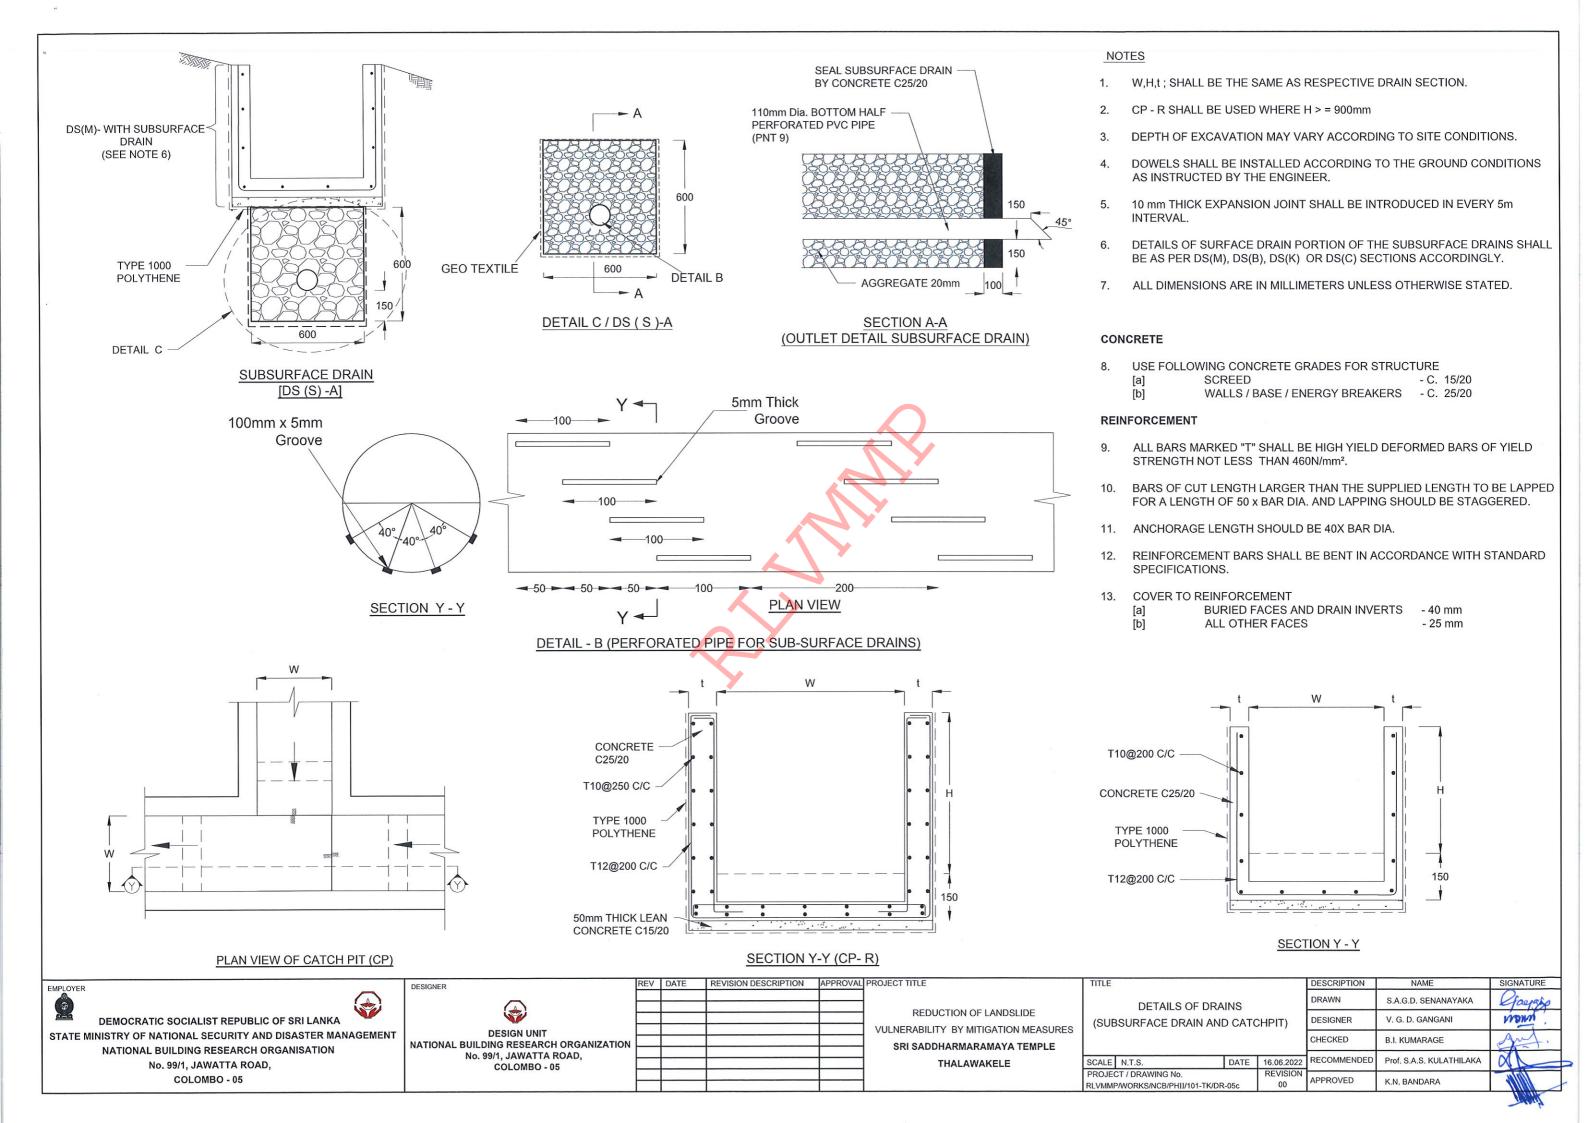

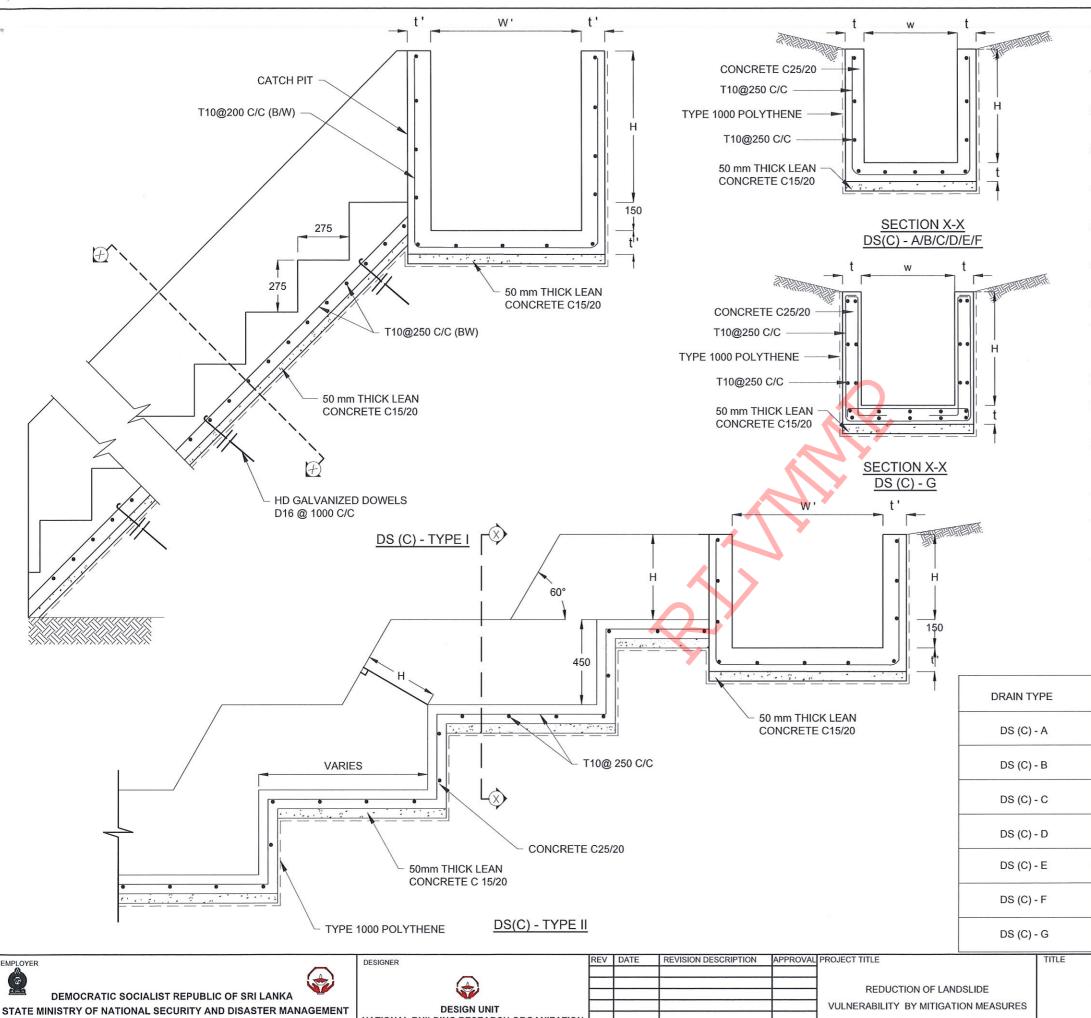

# NOTES

- USE EITHER TYPE I OR TYPE II CASCADE DRAIN ACCORDING TO THE ACTUAL GROUND CONDITION AS INSTRUCTED BY THE ENGINEER.
- LENGTH OF THE STEPS OF CASCADE WILL BE VARIED ACCORDING TO THE SITE CONDITIONS.
- DEPTH OF EXCAVATION SHALL BE VARIED ACCORDING TO SITE CONDITIONS.
- DOWELS SHALL BE INSTALLED ACCORDING TO THE GROUND CONDITIONS AS INSTRUCTED BY THE ENGINEER.
- 10 mm THICK EXPANSION JOINT SHALL BE INTRODUCED IN EVERY 5m INTERVAL.
- ALL DIMENSIONS ARE IN MILLIMETERS UNLESS OTHERWISE STATED.

#### CONCRETE

- 7. USE FOLLOWING CONCRETE GRADES FOR STRUCTURE
  - SCREED
  - [b] WALLS / BASE / ENERGY BREAKERS - C. 25/20

#### REINFORCEMENT

- ALL BARS MARKED "T" SHALL BE HIGH YIELD DEFORMED BARS OF YIELD STRENGTH NOT LESS THAN 460N/mm².
- BARS OF CUT LENGTH LARGER THAN THE SUPPLIED LENGTH TO BE LAPPED FOR A LENGTH OF 50 x BAR DIA. AND LAPPING SHOULD BE
- ANCHORAGE LENGTH SHOULD BE 40X BAR DIA.
- REINFORCEMENT BARS SHALL BE BENT IN ACCORDANCE WITH STANDARD SPECIFICATIONS.
- COVER TO REINFORCEMENT
  - BURIED FACES AND DRAIN INVERTS - 40 mm
  - ALL OTHER FACES - 25 mm

DRAIN TYPE	W (mm)	H (mm)	t (mm)	W ' (mm)	t'(mm)
DS (C) - A	450	450	100	600	100
DS (C) - B	450	600	100	750	100
DS (C) - C	600	600	100	800	100
DS (C) - D	750	750	100	800	100
DS (C) - E	800	800	125	1000	125
DS (C) - F	1000	750	125	1200	125
DS (C) - G	1200	1000	125	1300	125

STATE MINISTRY OF NATIONAL SECURITY AND DISASTER MANAGEMENT NATIONAL BUILDING RESEARCH ORGANISATION No. 99/1, JAWATTA ROAD,

COLOMBO - 05

_		
DESIGN UNIT		
NATIONAL BUILDING RESEARCH ORGANIZATION		_
No. 99/1, JAWATTA ROAD,		
COLOMBO - 05		


SRI SADDHARMARAMAYA TEMPLE **THALAWAKELE** 

	DETAILS OF DRA	INS		DRAWN	S.A.G.D. SENANAYAKA	Cheps		
(CASCADE DRAIN)				DESIGNER V. G. D. GANGANI		wom!		
				CHECKED	B.I. KUMARAGE	Aur.		
SCALE	N.T.S.	DATE	16.06.2022	RECOMMENDED	Prof. S.A.S. KULATHILAKA	NA.		
	CT / DRAWING No.	-05d	REVISION 00	APPROVED	K.N. BANDARA			

DESCRIPTION

NAME

SIGNATURE

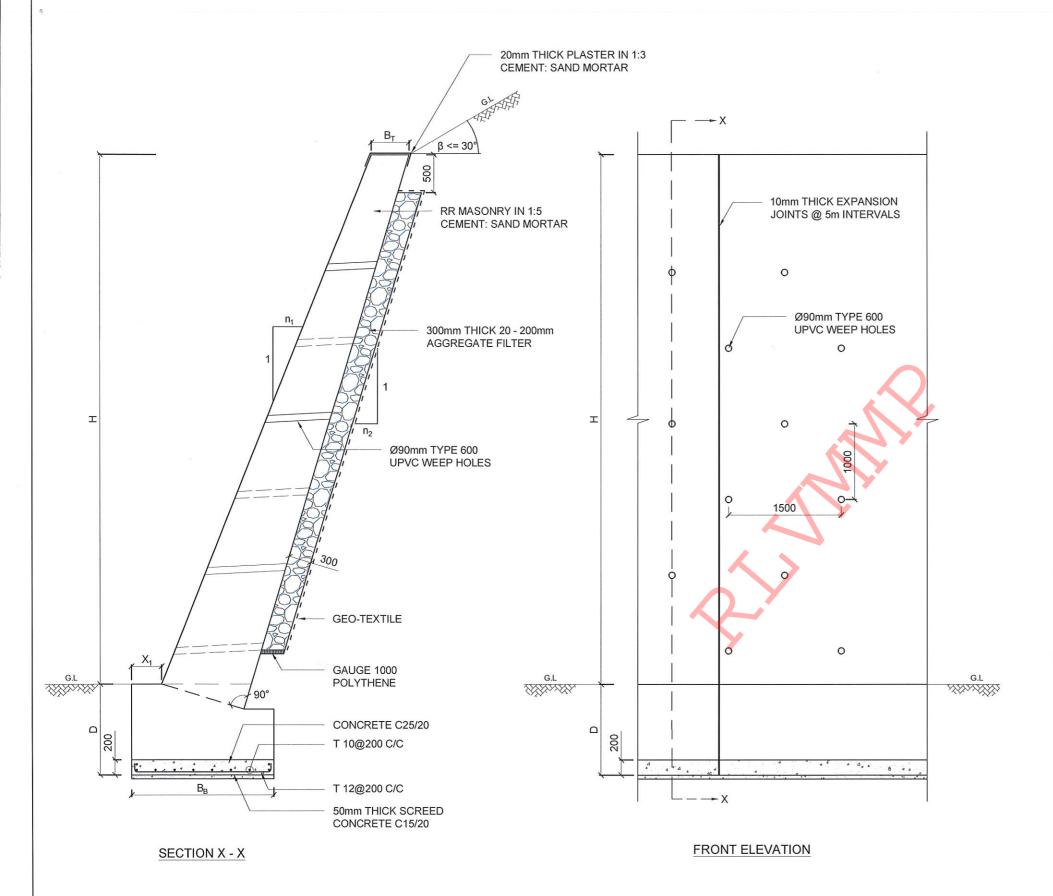

H / (m)	B <sub>T</sub> / (mm)	B <sub>B</sub> / (mm)	X <sub>1</sub> / (mm)	D/ (mm)	n <sub>1</sub>	n <sub>2</sub>
3.0	250	1400	300	600	0.4	0.2
4.0	300	1600	300	800	0.4	0.2
5.0	400	1800	300	1000	0.4	0.2

# NOTES

- WALL HEIGHT AND OTHER DIMENSIONS SHALL BE VARIED ACCORDING TO THE SLOPE CONDITION.
- b. WHERE THE EARTH CUT HEIGHT IS LESS THAN THAT OF THE APPLICABLE TYPICAL WALL HEIGHT, BACKFILLING SHALL BE DONE AS PER THE ENGINEER'S INSTRUCTIONS.
- c. 10mm THICK EXPANSION JOINTS SHOULD BE PROVIDED @ EVERY 5m INTERVALS.
- d. DOWELS SHALL BE INSTALLED IF HARD ROCK IS ENCOUNTERED AS PER THE ENGINEER'S INSTRUCTIONS.
- e. MINIMUM EMBEDMENT DEPTH (D), SHALL NOT BE LESS THAN 0.2 TIMES OF THE WALL HEIGHT (0.2H).

# CONCRETE

USE FOLLOWING CONCRETE GRADES FOR STRUCTURE

- a. SCREED GR. 15/20
- b. BASE GR. 25/20

# REINFORCEMENT

- a. ALL BARS MARKED "T" SHALL BE HIGH YIELD DEFORMED BARS OF YIELD STRENGTH NOT LESS THAN 460N/mm².
- b. BARS OF CUT LENGTH LARGER THAN THE SUPPLIED LENGTH TO BE LAPPED WITH LENGTH OF 50Ø, WHERE Ø IS THE DIAMETER AND LAPPING SHOULD BE STAGGERED.
- c. ANCHORAGE LENGTH SHOULD BE 40 x BAR DIA.
- d. CLEAR CONCRETE COVER FOR ALL FOUNDATION REINFORCEMENT BELLOW GROUND LEVEL TO BE 50 mm.

SIGNATURE

EMPLOYER	R	DESIGNER	REV	DATE	REVISION DESCRIPTION	APPROVAL	PROJECT TITLE	TITLE		DESCRIPTION	NAME
9						-				DRAWN	S.A.G.D. SENANAYAKA
<u> </u>	DEMOCRATIC SOCIALIST REPUBLIC OF SRI LANKA						REDUCTION OF LANDSLIDE  VULNERABILITY BY MITIGATION MEASURES	DETAILS OF TYPICAL LEANING RETAINING WALLS	TYPE	DESIGNER	V. G. D. GANGANI
STATE	MINISTRY OF NATIONAL SECURITY AND DISASTER MANAGEMENT NATIONAL BUILDING RESEARCH ORGANISATION	NATIONAL BUILDING RESEARCH ORGANIZATION					SRI SADDHARMARAMAYA TEMPLE			CHECKED	B.I. KUMARAGE
	No. 99/1, JAWATTA ROAD,	No. 99/1, JAWATTA ROAD, COLOMBO - 05					THALAWAKELE			RECOMMENDED	Prof. S.A.S. KULATHILAKA
	COLOMBO - 05					-		PROJECT / DRAWING No. RLVMMP/WORKS/NCB/PHII/101-TK/DR-06	REVISION 00	APPROVED	K.N. BANDARA

# Site No.103



TF **TOILET FIT** TL TOILET LF LIVE FENCE В **BANK** B(B) BANK BOTAM B(T) **BANK TOP** BW **BOUNDARY WALL** WF WIRE FENCE GB **GABIAN WALL** RW RETAINING WALL

**GATE** 

TW TOE WALL

**TBM** TEMPORARY BENCH MARK

SR SRINE ROOM MDN MASONRY DRAIN

ARB ASBESTOS ROOFED BUILDING CRB CONCRETE ROOFED BUILDING

3SARB THREE STORIED ASBESTOS ROOFED BUILDING

# **DESIGN NOTATION**

A A A A A

SOIL NAILING AREA



CANTILEVER WALL (2m)



BACKFILLING AND ROAD SURFACE REPAVING



**TURFING AREA** 



DS (M) - L

DS (K) - A (TYPE I)

# NOTES

1. COVER SLABS SHALL BE INSTALLED TO THE CUTOFF DRAINS AS PER THE INSTRUCTION OF THE ENGINEER IN NECESSARY LOCATIONS ACCORDING TO THE SITE CONDITIONS.

DEMOCRATIC SOCIALIST REPUBLIC OF SRI LANKA STATE MINISTRY OF NATIONAL SECURITY AND DISASTER MANAGEMENT NATIONAL BUILDING RESEARCH ORGANISATION No. 99/1, JAWATTA ROAD, COLOMBO - 05

WT

CS - A05

CS - A04

CS - A03

CS - A02

CS - A01


FROM VILLAGE


DESIGNER DESIGN UNIT NATIONAL BUILDING RESEARCH ORGANIZATION No. 99/1, JAWATTA ROAD,

COLOMBO - 05

REDUCTION OF LANDSLIDE VULNERABILITY BY MITIGATION MEASURES LIYANWALA MAHA VIDYALAYA

1	TITLE			DESCRIPTION	NAME	SIGNATURE
				DRAWN	S.A.G.D. SENANAYAKA	Gayou
	DESIGN PLAN V		DESIGNER	D.M.D.T. DASANAYAKA	Southy	
			CHECKED	B.I. KUMARAGE	Long	
	SCALE 1:600	DATE	25.05.2022	RECOMMENDED	Prof. S.A.S. KULATHILAKA	all
PROJECT / DRAWING No. RLVMMP/WORKS/NCB/PHII/103-LI/DR-03		REVISION 00	APPROVED	K.N. BANDARA		

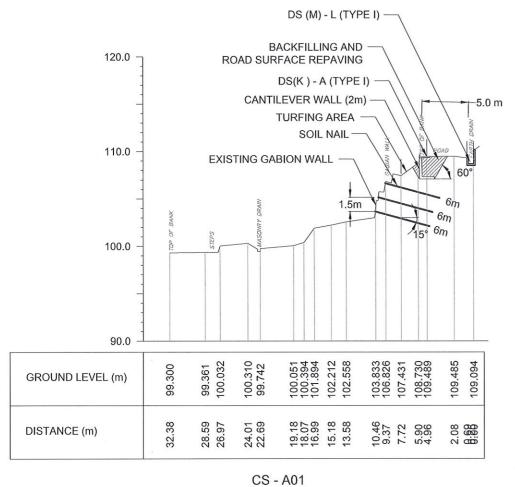

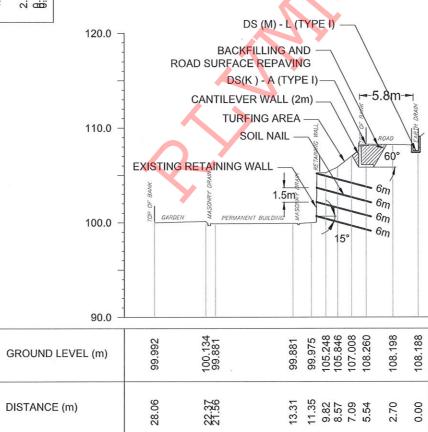

CS - A03

REV DATE REVISION DESCRIPTION APPROVAL PROJECT TITLE

DS (M) - L (TYPE I) BACKFILLING AND 120.0 ROAD SURFACE REPAVING DS(K) - A (TYPE I) CANTILEVER WALL (2m) -5.0 m **TURFING AREA** SOIL NAIL 110.0 EXISTING RETAINING WALL: 100.0 90.0 189:353 105.439 106.549 108.058 108.787 188.742 99.927 GROUND LEVEL (m) 13.13 16.93 9.10 7.43 5.74 4.64 2.30 8.86 DISTANCE (m)

CS - A02

DEMOCRATIC SOCIALIST REPUBLIC OF SRI LANKA
STATE MINISTRY OF NATIONAL SECURITY AND DISASTER MANAGEMENT


NATIONAL BUILDING RESEARCH ORGANISATION No. 99/1, JAWATTA ROAD, COLOMBO - 05

DESIGN UNIT NATIONAL BUILDING RESEARCH ORG No. 99/1, JAWATTA ROAD COLOMBO - 05	


DESIGNER

	REDUCTION OF LANDSLIDE
	VULNERABILITY BY MITIGATION MEASURES
	LIYANWALA MAHA VIDYALAYA
	LITANWALA WAHA VIDTALATA

TITLE			DESCRIPTION	NAME	SIGNATURE
			DRAWN	S.A.G.D. SENANAYAKA	Gayos
DESIGN CROSS SE	CTION		DESIGNER	D.M.D.T. DASANAYAKA	Shetly
		CHECKED	B.I. KUMARAGE	distribution	
SCALE 1:500	DATE	25.05.2022	RECOMMENDED	Prof. S.A.S. KULATHILAKA	di
PROJECT / DRAWING No. REVISION RLVMMP/WORKS/NCB/PHII/103-LI/DR-04a 00			APPROVED	K.N. BANDARA	

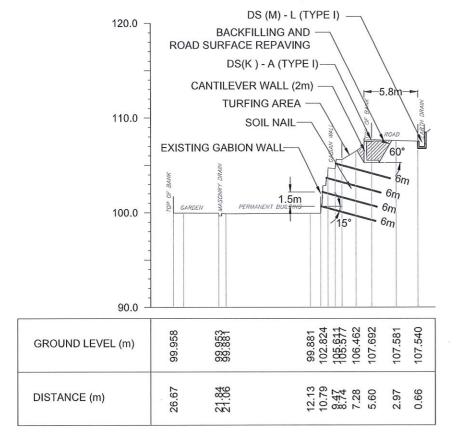

CS - A04

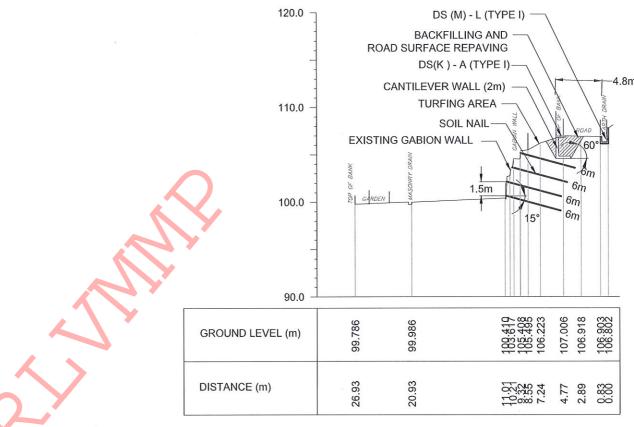


CS - A05

EMPLOYER
DEMOCRATIC SOCIALIST REPUBLIC OF SRI LANKA
STATE MINISTRY OF NATIONAL SECURITY AND DISASTER MANAGEMENT
NATIONAL BUILDING RESEARCH ORGANISATION
No. 99/1, JAWATTA ROAD,
COLOMBO - 05

DESIGNER	REV	DATE	REVISION DESCRIPTION
DESIGN UNIT NATIONAL BUILDING RESEARCH ORGANIZATION No. 99/1, JAWATTA ROAD, COLOMBO - 05			

_	
	REDUCTION OF LANDSLIDE
	VULNERABILITY BY MITIGATION MEASURES
	LIYANWALA MAHA VIDYALAYA

TITLE			DESCRIPTION	NAME	SIGNATURE
			DRAWN	S.A.G.D. SENANAYAKA	Crayon
DESIGN CROSS SE		DESIGNER	D.M.D.T. DASANAYAKA	Lastly	
			CHECKED	B.I. KUMARAGE	South
SCALE 1:500	DATE	25.05.2022	RECOMMENDED	Prof. S.A.S. KULATHILAKA	
1110020170101111101101			APPROVED	K.N. BANDARA	
	DESIGN CROSS SE  SCALE 1:500  PROJECT / DRAWING No.	DESIGN CROSS SECTION  SCALE 1:500 DATE PROJECT / DRAWING No.	DESIGN CROSS SECTION           SCALE         1:500         DATE         25.05.2022           PROJECT / DRAWING No.         REVISION	DESIGN CROSS SECTION	DESIGN CROSS SECTION         DRAWN         S.A.G.D. SENANAYAKA           DESIGNER         D.M.D.T. DASANAYAKA           CHECKED         B.I. KUMARAGE           SCALE         1:500         DATE         25.05.2022         RECOMMENDED         Prof. S.A.S. KULATHILAKA           PROJECT / DRAWING No.         REVISION         APPROVED         K.N. BANDARA

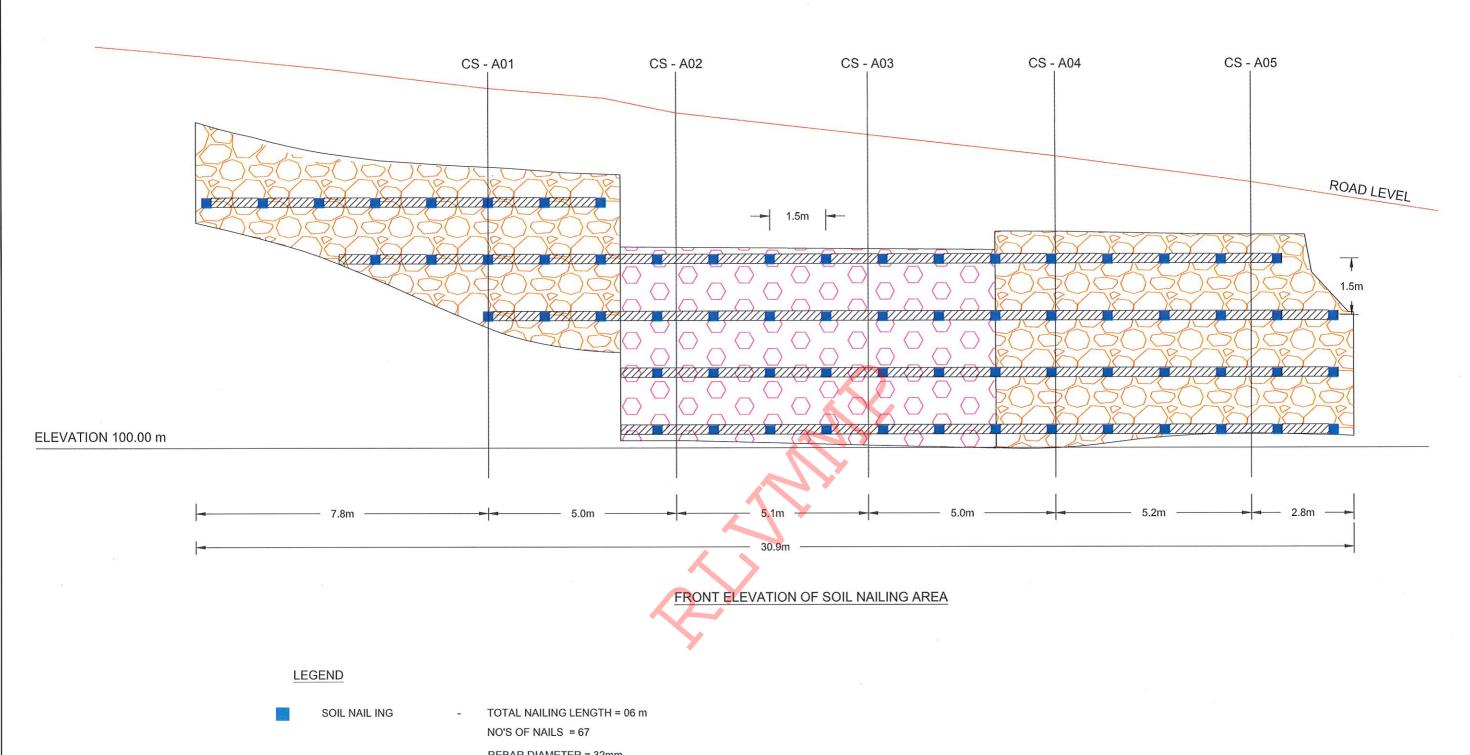

REVISION DESCRIPTION APPROVAL PROJECT TITLE

REBAR DIAMETER = 32mm

DIAMETER OF THE BOREHOLE = 125mm

GABION WALL FACE

RETAINING WALL FACE

DESIGNER

GRID BEAMS CONNECTING SOIL NAILS ON THE WALL FACE

# NOTES


- 1. SURFACE AND CASCADE DRAIN LOCATIONS (PATH) & LENGTHS MIGHT BE VARIED ACCORDING TO ACTUAL SITE CONDITION.
- 2. LOCATION OF THE CATCHPITS MIGHT BE VARIED ACCORDING TO THE ACTUAL SITE CONDITION.

EMPLOYER DEMOCRATIC SOCIALIST REPUBLIC OF SRI LANKA STATE MINISTRY OF NATIONAL SECURITY AND DISASTER MANAGEMENT NATIONAL BUILDING RESEARCH ORGANISATION No. 99/1, JAWATTA ROAD, COLOMBO - 05


DESIGN UNIT	١
NATIONAL BUILDING RESEARCH ORGANIZATION	١
No. 99/1, JAWATTA ROAD,	I
COLOMBO - 05	١
	١


REDUCTION OF LANDSLIDE
VULNERABILITY BY MITIGATION MEASURES
LIYANWALA MAHA VIDYALAYA


	TITLE			DESCRIPTION	NAME	SIGNATURE
				DRAWN	S.A.G.D. SENANAYAKA	Gayos
	FRONT ELEVAT	ION		DESIGNER	D.M.D.T. DASANAYAKA	Smoth
				CHECKED	B.I. KUMARAGE	Luch
	SCALE 1:100	DATE	25.05.2022	RECOMMENDED	Prof. S.A.S. KULATHILAKA	M
1	3CALE 1.100	DAIL				elette
	PROJECT / DRAWING No.	REVISION	APPROVED	K.N. BANDARA	411111	
	RLVMMP/WORKS/NCB/PHII/103-LI/DR-05 00			ALL KOVED	K.N. BANDAKA	

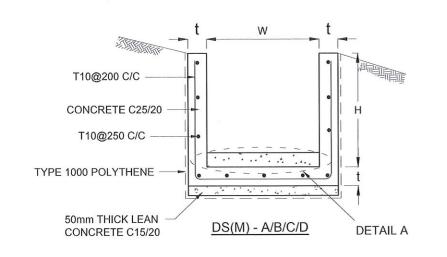


DRAIN TYPE	W (mm)	H (mm)	t (mm)
DS (M) - A /P	300	300	100
DS (M) - B/R	450	450	100
DS (M) - C/Q	600	600	100
DS (M) - D	750	750	125
DS (M) - E	900	900	150
DS (M) - F	1000	1000	150

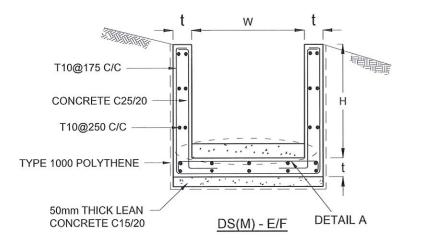

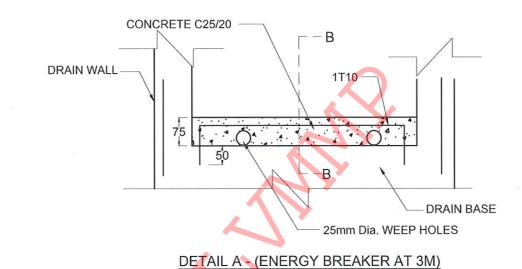

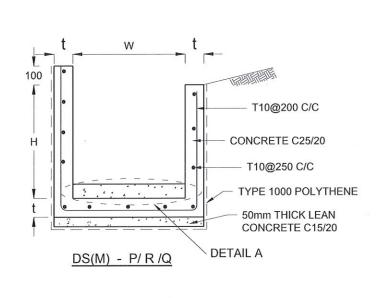

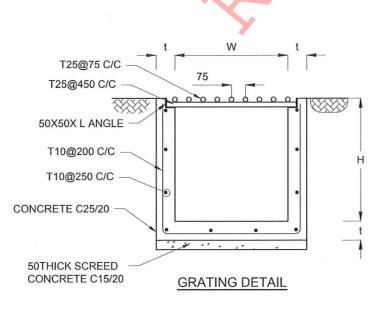

# **NOTES**

- DEPTH OF EXCAVATION MAY VARY ACCORDING TO SITE CONDITIONS.
- STEPS SHALL BE CONSTRUCTED AT SURFACE DRAIN ON SLOPING GROUND ACCORDING TO THE SITE CONDITIONS AS INSTRUCTED BY THE ENGINEER.
- ENERGY BREAKERS SHALL BE CONSTRUCTED AT THE STEEP DRAIN SEGMENTS AS PER THE INSTRUCTIONS OF THE ENGINEER.
- DOWELS SHALL BE INSTALLED ACCORDING TO THE GROUND CONDITIONS AS INSTRUCTED BY THE ENGINEER.
- ALL DIMENSIONS ARE IN MILLIMETERS UNLESS OTHERWISE STATED.
- 10 mm THICK EXPANSION JOINT SHALL BE INTRODUCED IN EVERY 5m INTERVAL.

#### CONCRETE

- 7. USE FOLLOWING CONCRETE GRADES FOR STRUCTURE
  - C. 15/20
  - WALLS / BASE / ENERGY BREAKERS - C. 25/20

#### REINFORCEMENT

- ALL BARS MARKED "T" SHALL BE HIGH YIELD DEFORMED BARS OF YIELD STRENGTH NOT LESS THAN 460N/mm2.
- BARS OF CUT LENGTH LARGER THAN THE SUPPLIED LENGTH TO BE LAPPED FOR A LENGTH OF 50 x BAR DIA. AND LAPPING SHOULD BE STAGGERED.
- ANCHORAGE LENGTH SHOULD BE 40X BAR DIA.
- REINFORCEMENT BARS SHALL BE BENT IN ACCORDANCE WITH STANDARD SPECIFICATIONS.
- 12. COVER TO REINFORCEMENT
  - BURIED FACES AND DRAIN INVERTS - 40 mm
  - ALL OTHER FACES - 25 mm

CONCRETE C 25/20 150 50X50 WELDED -50 **GALVANIZED MESH DETAILS OF BERM SEALING** 10 mm THICK JOINT SEALANT 10 mm THICK POLYSTYRENE -75 1Y10-SECTION B-B **EXPANTION JOINT DETAIL** 

DEMOCRATIC SOCIALIST REPUBLIC OF SRI LANKA STATE MINISTRY OF NATIONAL SECURITY AND DISASTER MANAGEMENT NATIONAL BUILDING RESEARCH ORGANISATION No. 99/1, JAWATTA ROAD, COLOMBO - 05

EMPLOYER

DESIGNER **DESIGN UNIT** NATIONAL BUILDING RESEARCH ORGANIZATION No. 99/1, JAWATTA ROAD, COLOMBO - 05


REDUCTION OF LANDSLIDE VULNERABILITY BY MITIGATION MEASURES LIYANWALA MAHA VIDYALAYA


REVISION DESCRIPTION | APPROVAL PROJECT TITLE


**DETAILS OF DRAINS** (SURFACE DRAIN -1 OF 2)


PROJECT / DRAWING No.


SIGNATURE DESCRIPTION NAME DRAWN S.A.G.D. SENANAYAKA DESIGNER D.M.D.T. DASANAYAKA CHECKED **B.I. KUMARAGE** DATE 25.05.2022 RECOMMENDED Prof. S.A.S. KULATHILAKA APPROVED K.N. BANDARA 00 RLVMMP/WORKS/NCB/PHII/103-LI/DR-05a

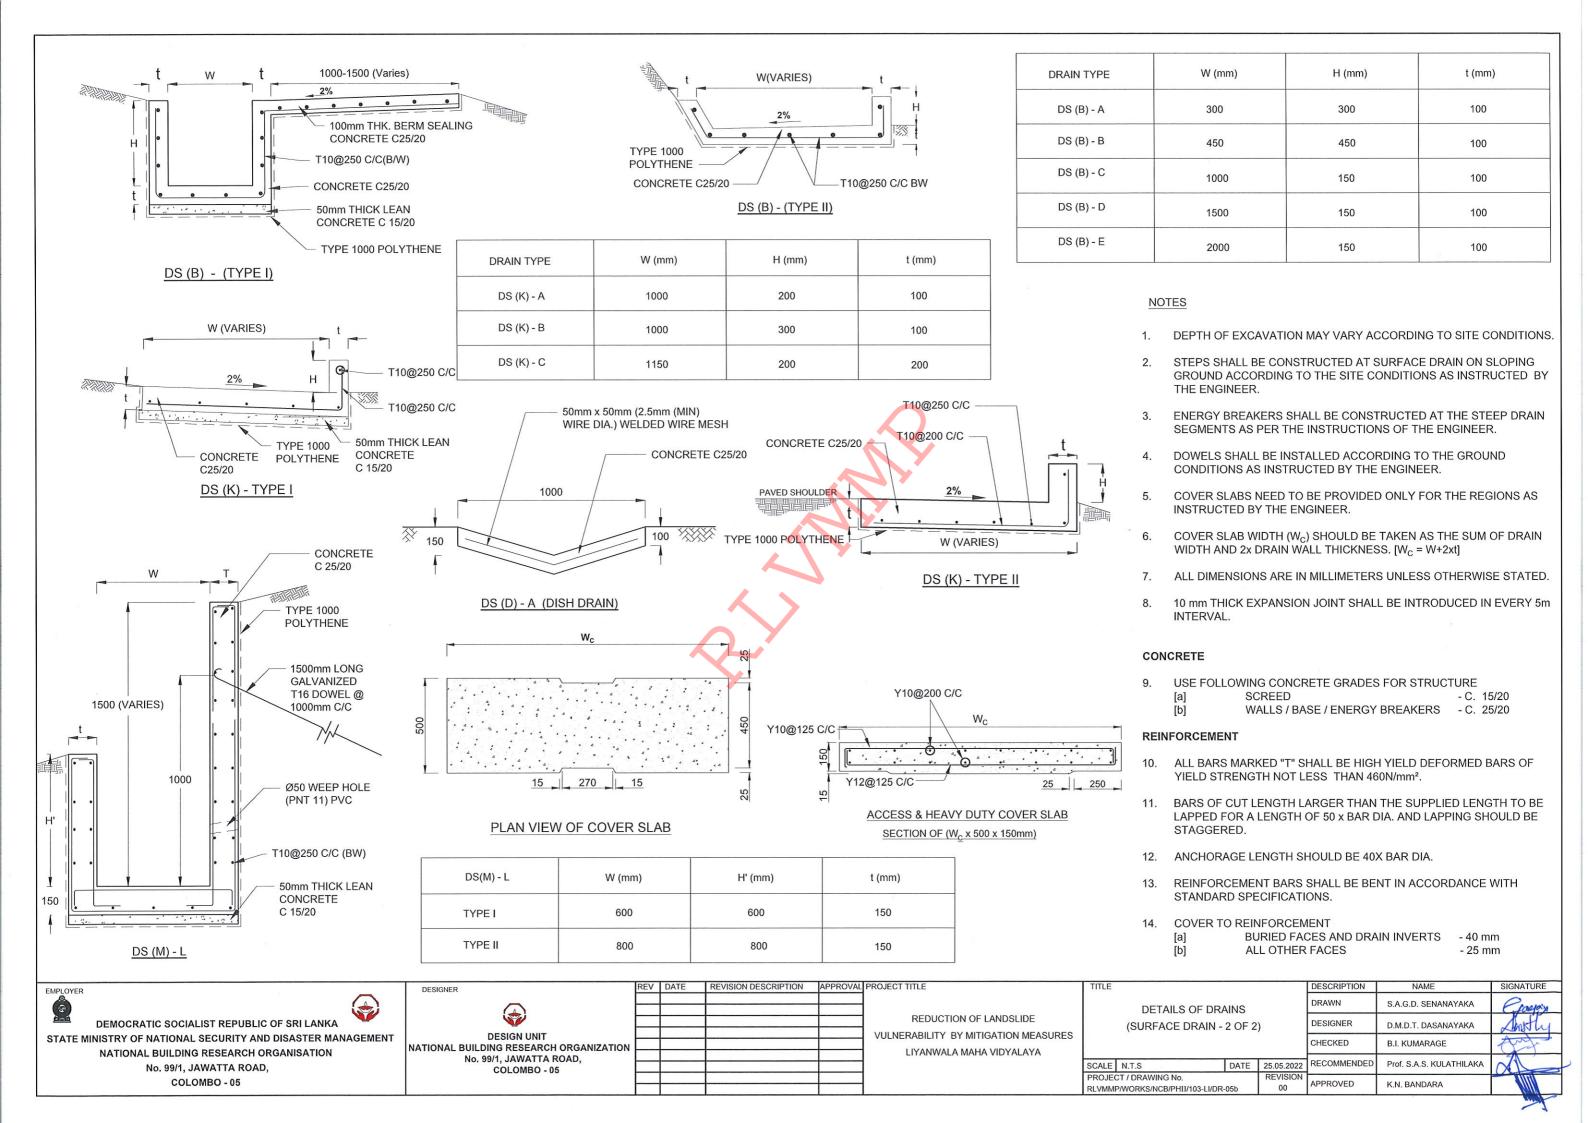

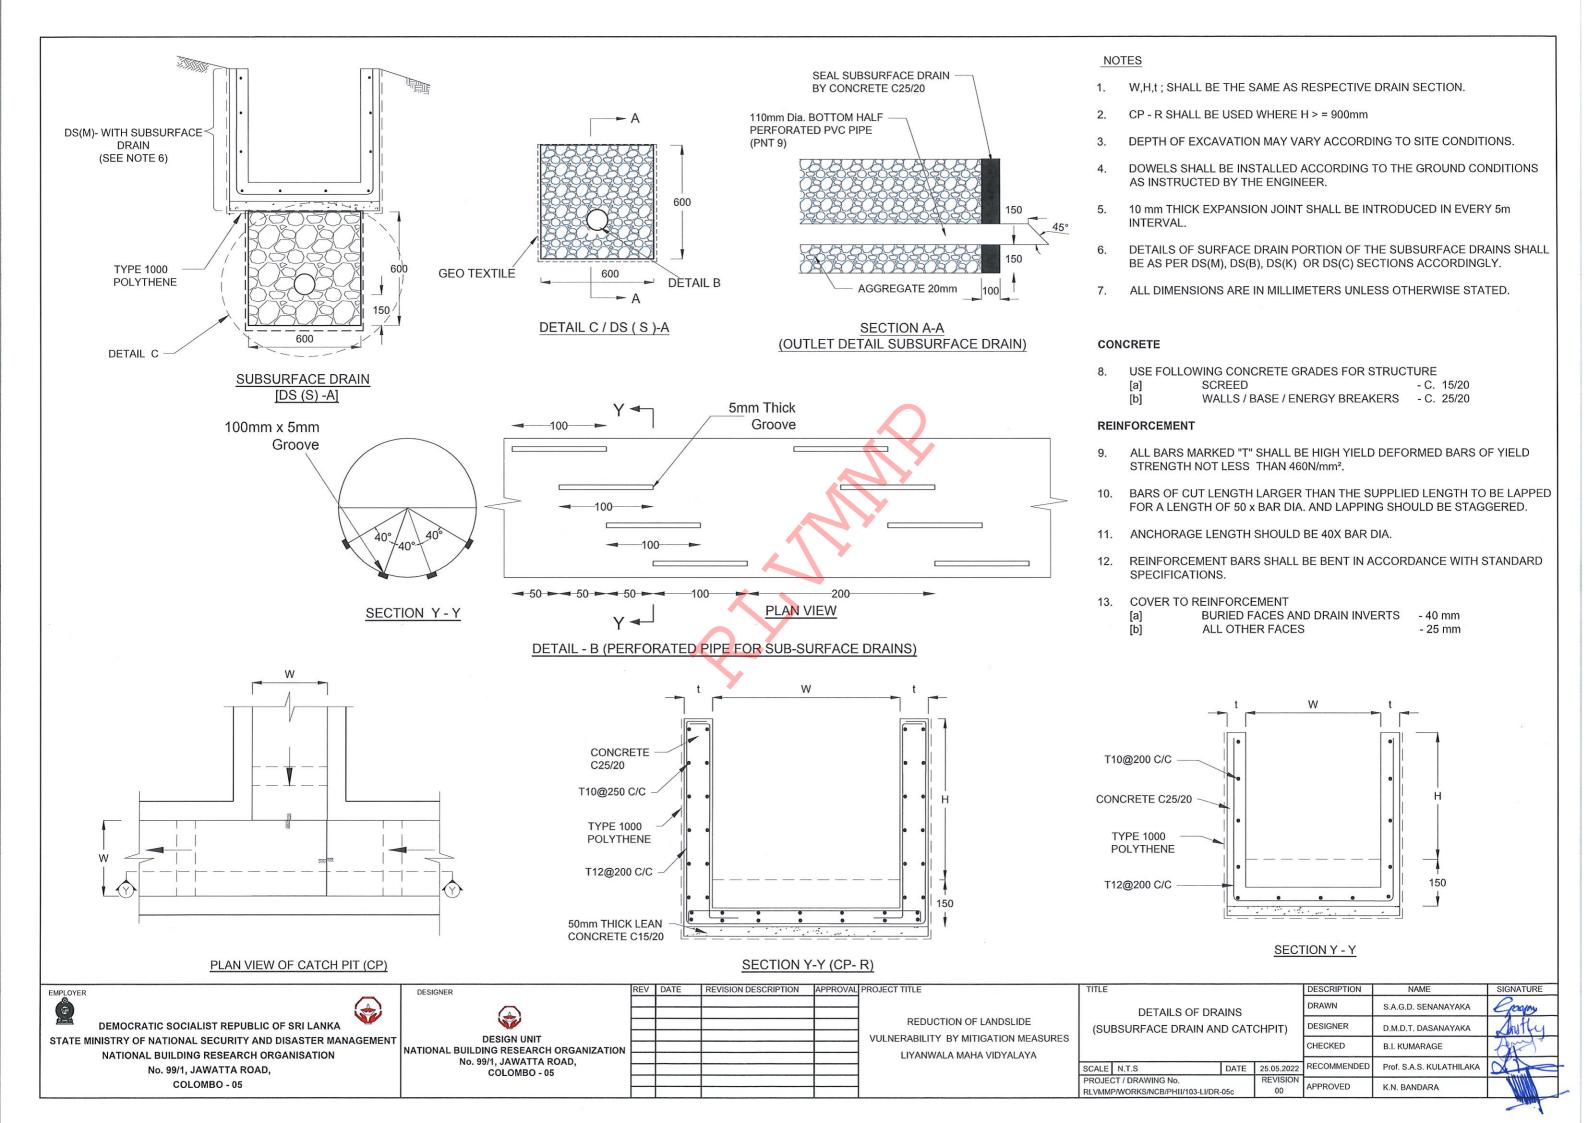

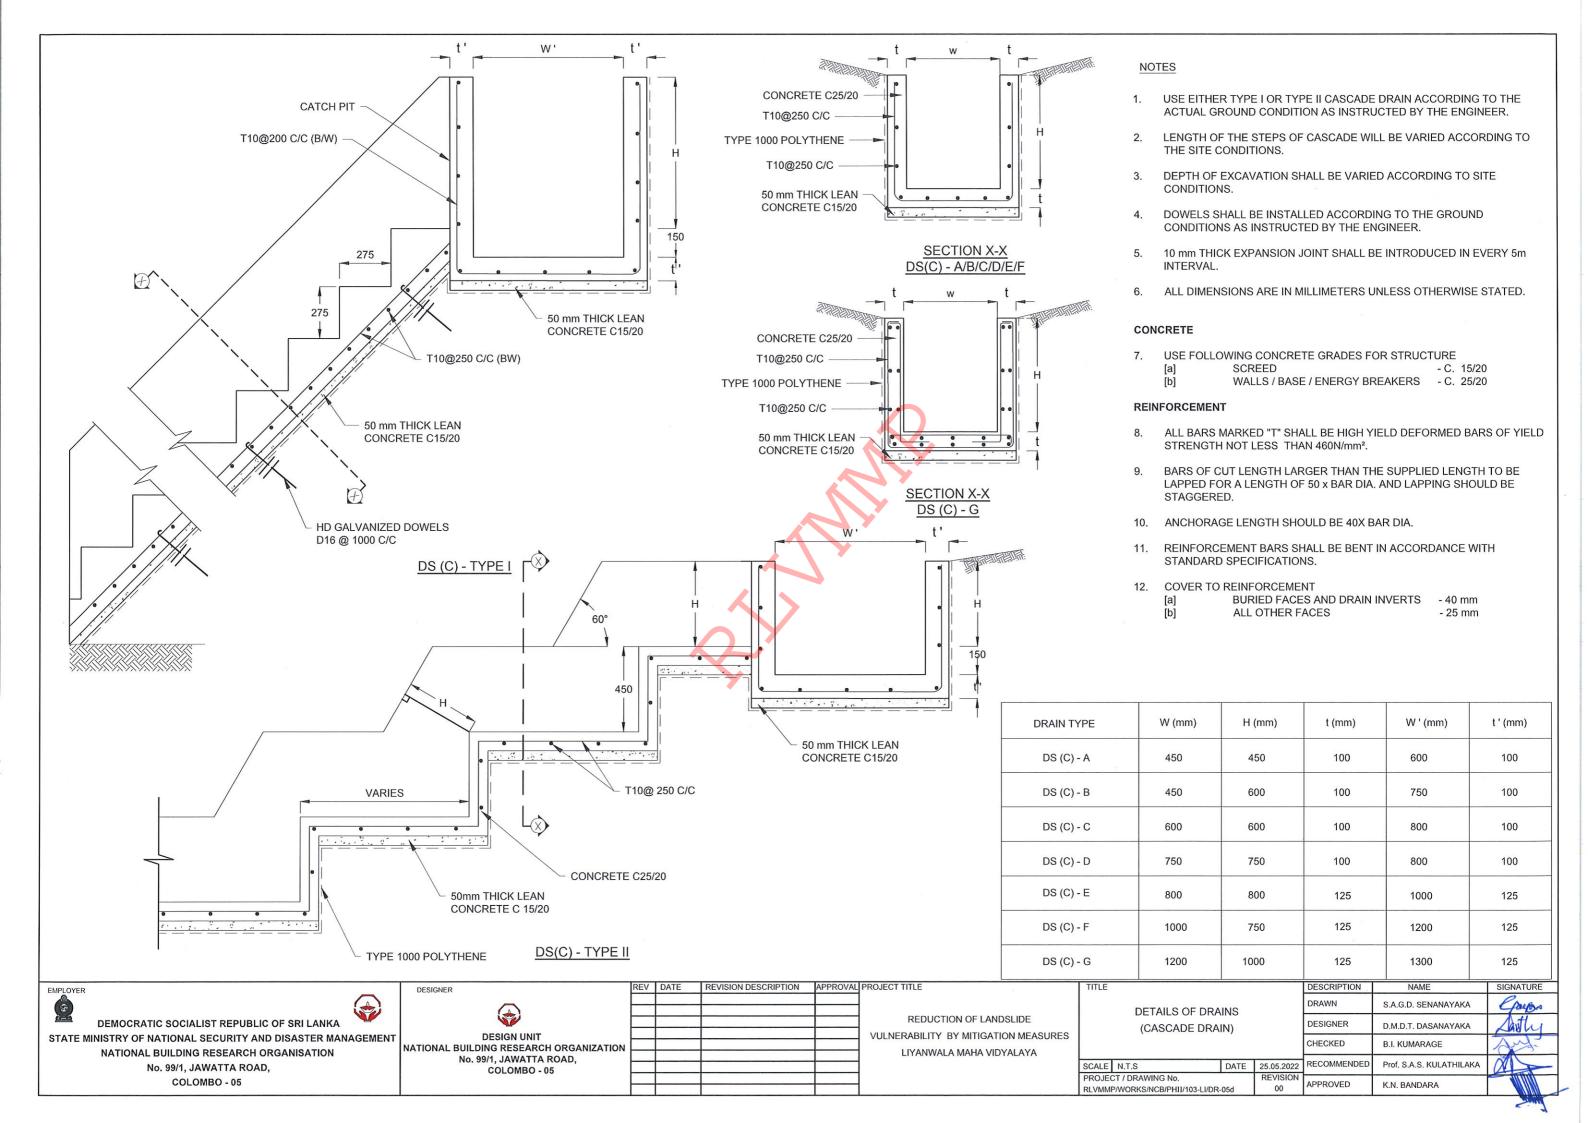

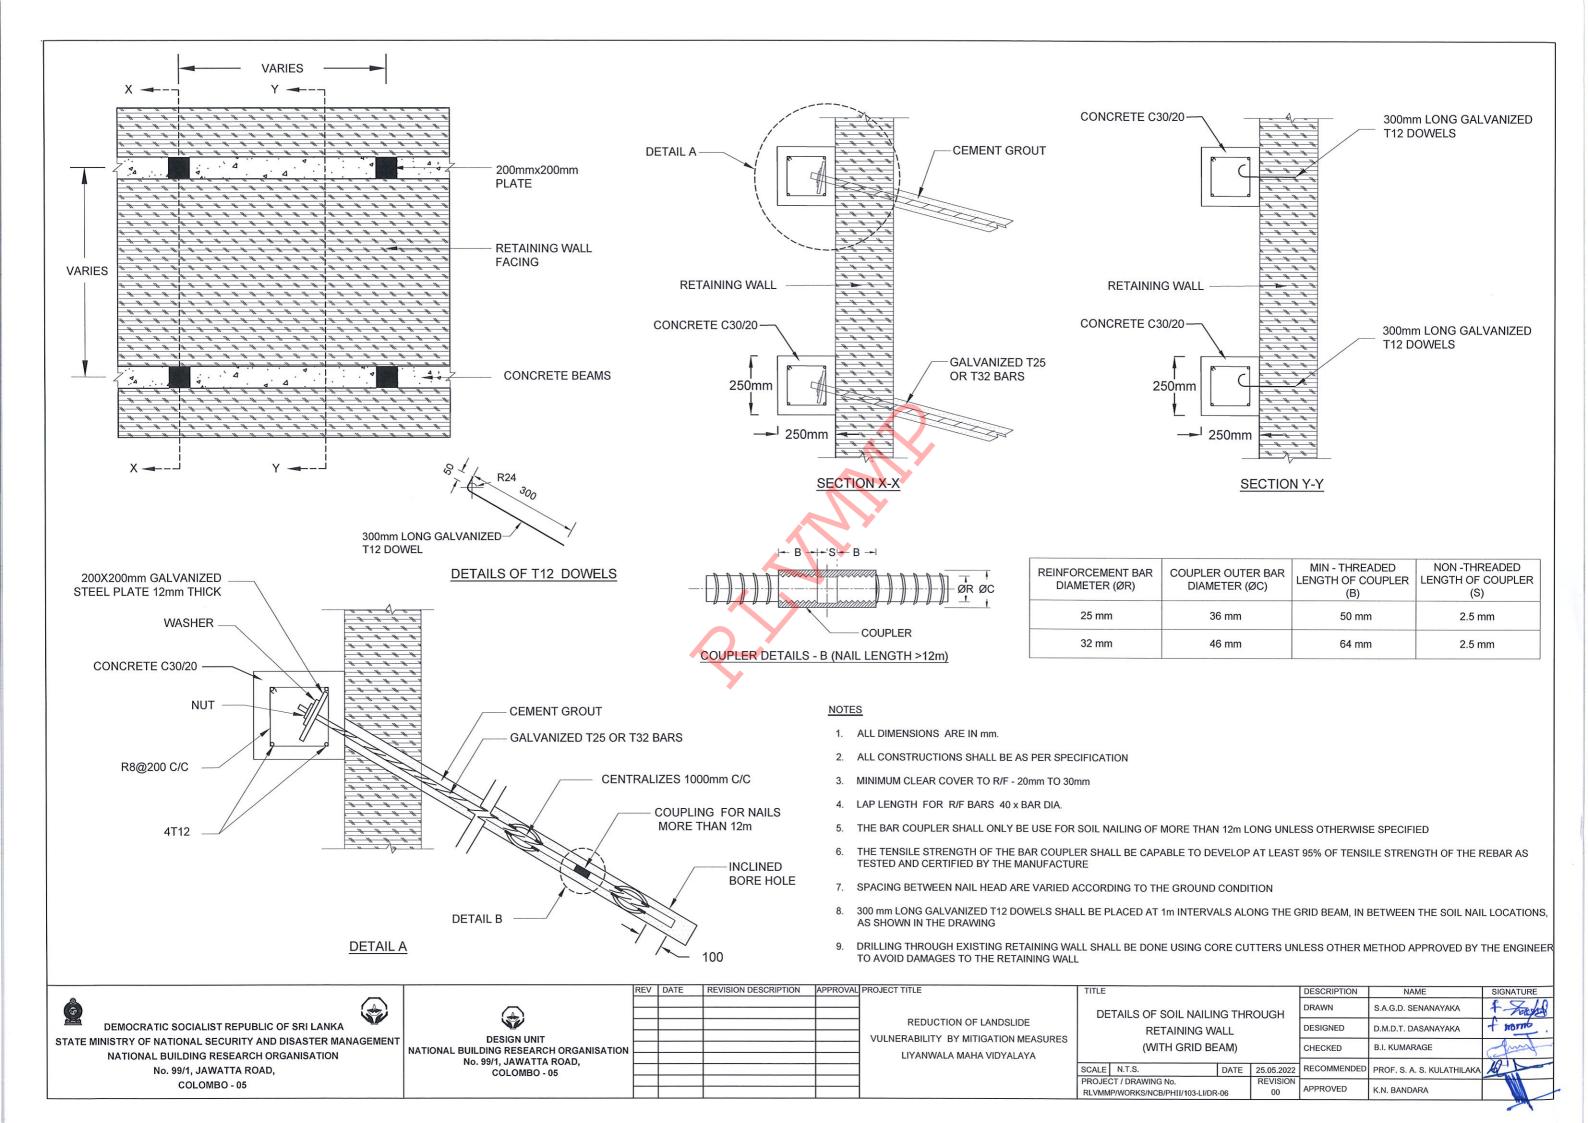

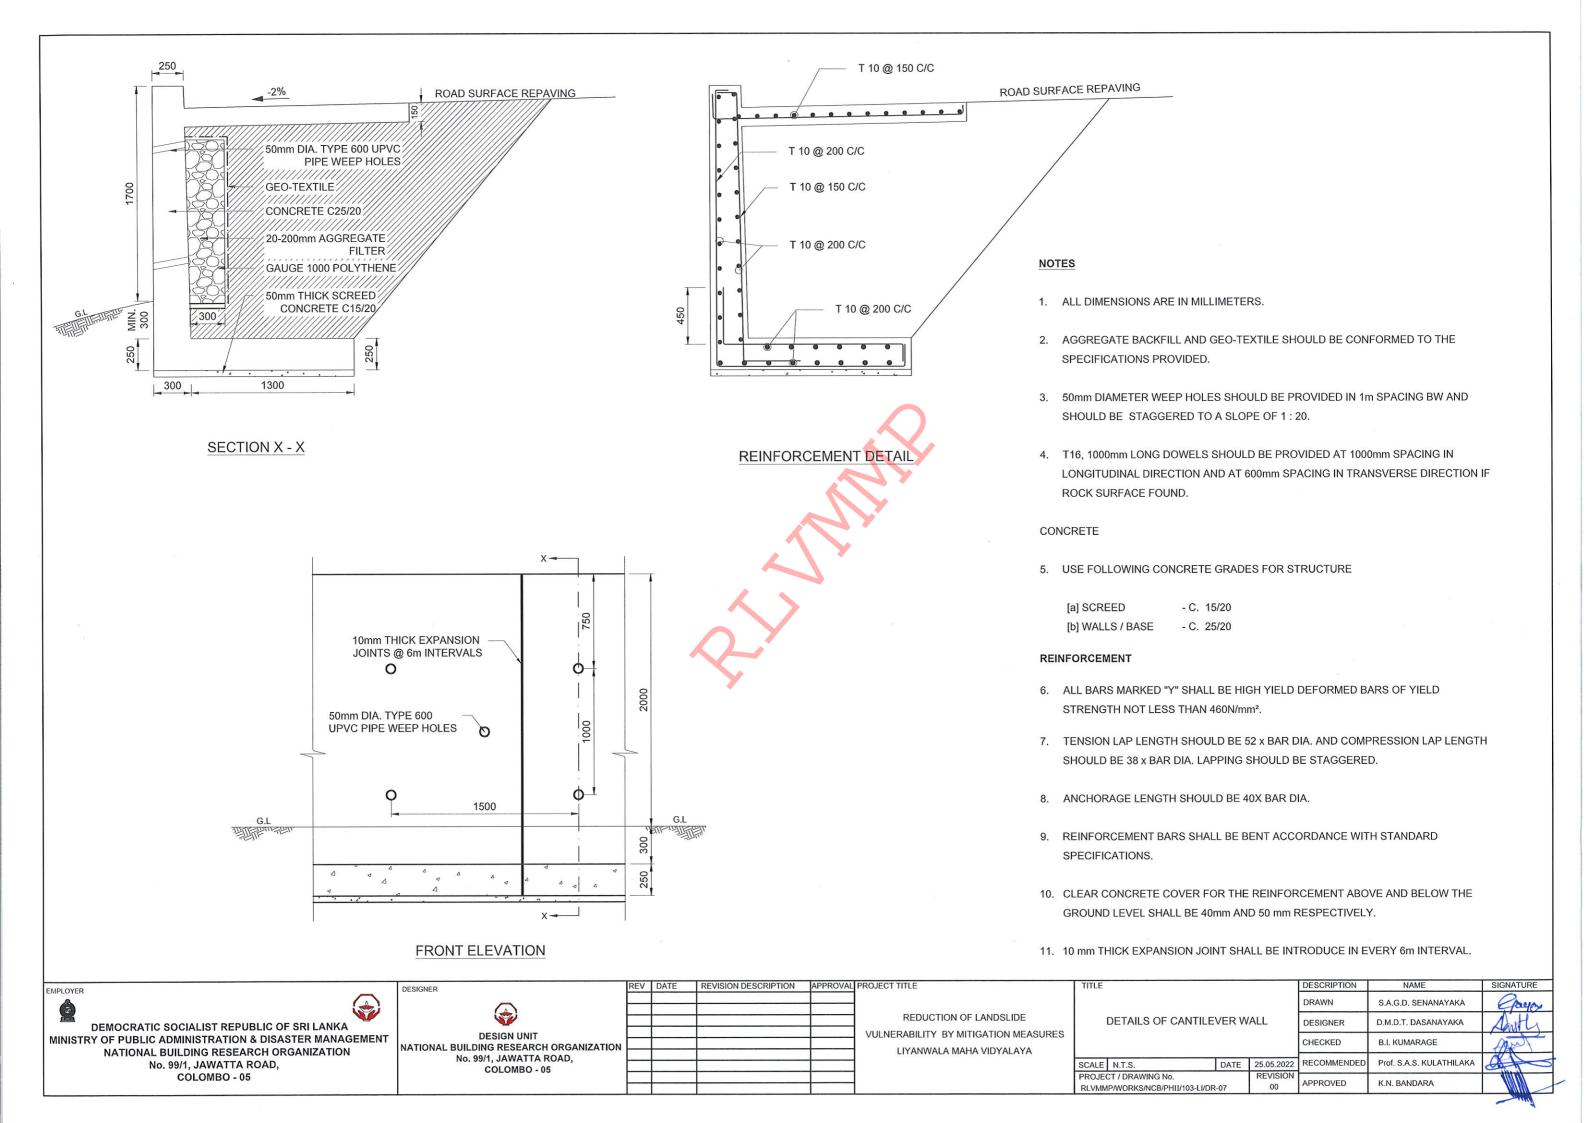



# FLAT PLAN OF SEETHA-ELIYA TEMPLE FROM HOUSES (C) E DUMP AREA (1) (A) (3)CULTIVATION (11) 125 (B) ROAD (4) (9) 120 11510 FROM NUMARAEL NA ROAD (H) (8) (6)

### REFERENCE

BD - BUILDING

BM - BENCH MARK

BO - BODHIYA

BT - BELL TOWER

**CUL - CULVERT** 

GW - GABION WALL

LT - LATRINE

MDN - MASONRY DRAIN

NF - NET FENCE

ROAD(H) - ROAD(HIGH WAYS)

RW - RETAINING WALL

TBM - TEMPORARY BENCH MARK

NOTE: HEIGHTS ARE BASED ON ARBITRARY DATUM

REFERENCE HEIGHT POINT(TBM) WAS MARKED ON GROUND AND ELEVATION WAS MENTIONED BELOW.

**BENCH MARK HEIGHTS** 

BM 1 - 103.226 TBM 1 - 96.225

TBM 2 - 104.456

ANDCH

LANDSLIDE RESEARCH & RISK MANAGEMENT DIVISION
NATIONAL BUILDING RESEARCH ORGANIZATION
No. 99/1 ,JAWATTA ROAD
COLOMBO - 05

GEO - TECHNICAL DESIGN

DESIGN UNIT

NATIONAL BUILDING RESEARCH ORGANIZATION


No. 99/1 ,JAWATTA ROAD


COLOMBO - 05


	REV	DATE	REVISION DESCRIPTION	APPROVAL	PROJECT TITLE
	$\Box$				
	$\vdash$			+	
	$\vdash$				REDU
					INLIDO
	$\vdash$			_	
	$\vdash$			+	
	$\sqcup$				
ı	$\vdash$				
	$\vdash$		15.05.00	_	
			PAGE NO.		

REDUCTION OF LANDSLIDE VULNERABILITY
BY MITIGATION MEASURES
SEETHA- ELIYA TEMPLE
SITE NO. 42

TITLE				DESCRIPTION	NAME	
CONTOUR SURVEY PLAN  SCALE 1:1000 DATE 19-04-2				SURVEYED		
	CONTOUR SURV	EY PLAN	1	DRAWN		
				CHECKED	H.R. Worderston	Regile.
SCALE	1:1000	DATE	19-04-2022			3
	T / DRAWING No.	DATE	REVISION		·	
	WORKS/NCB/06/42/DR	- 01	00			

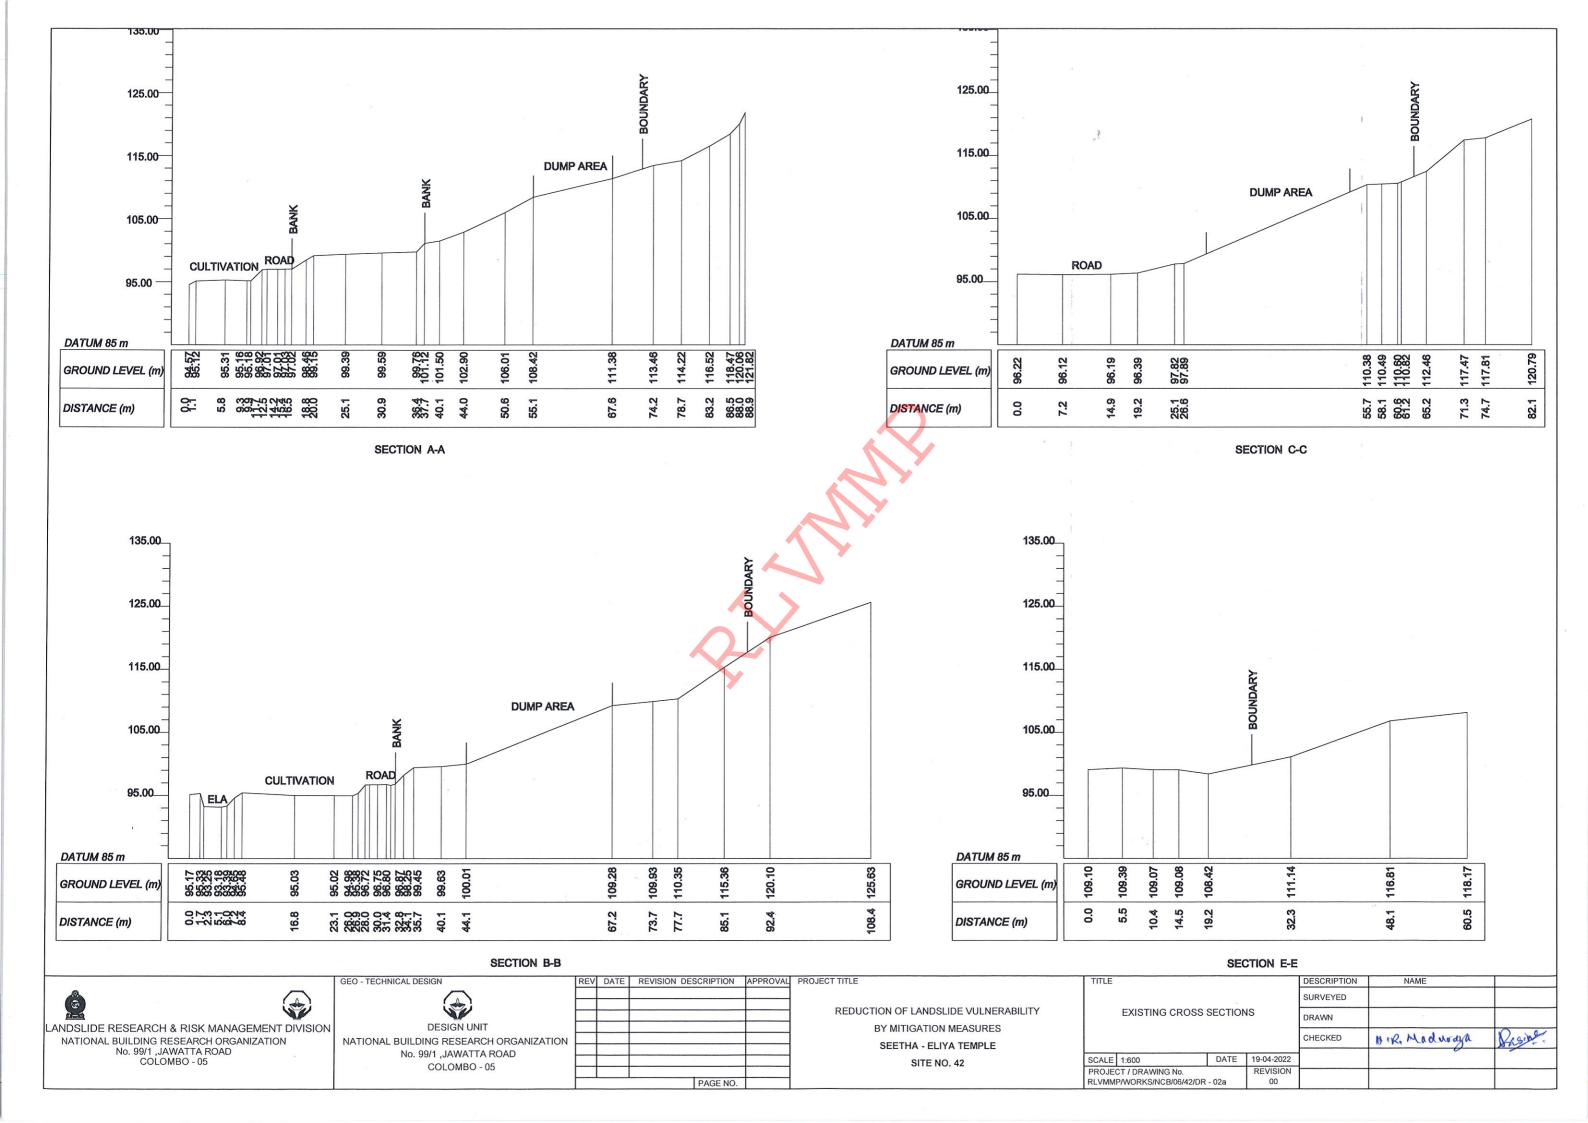


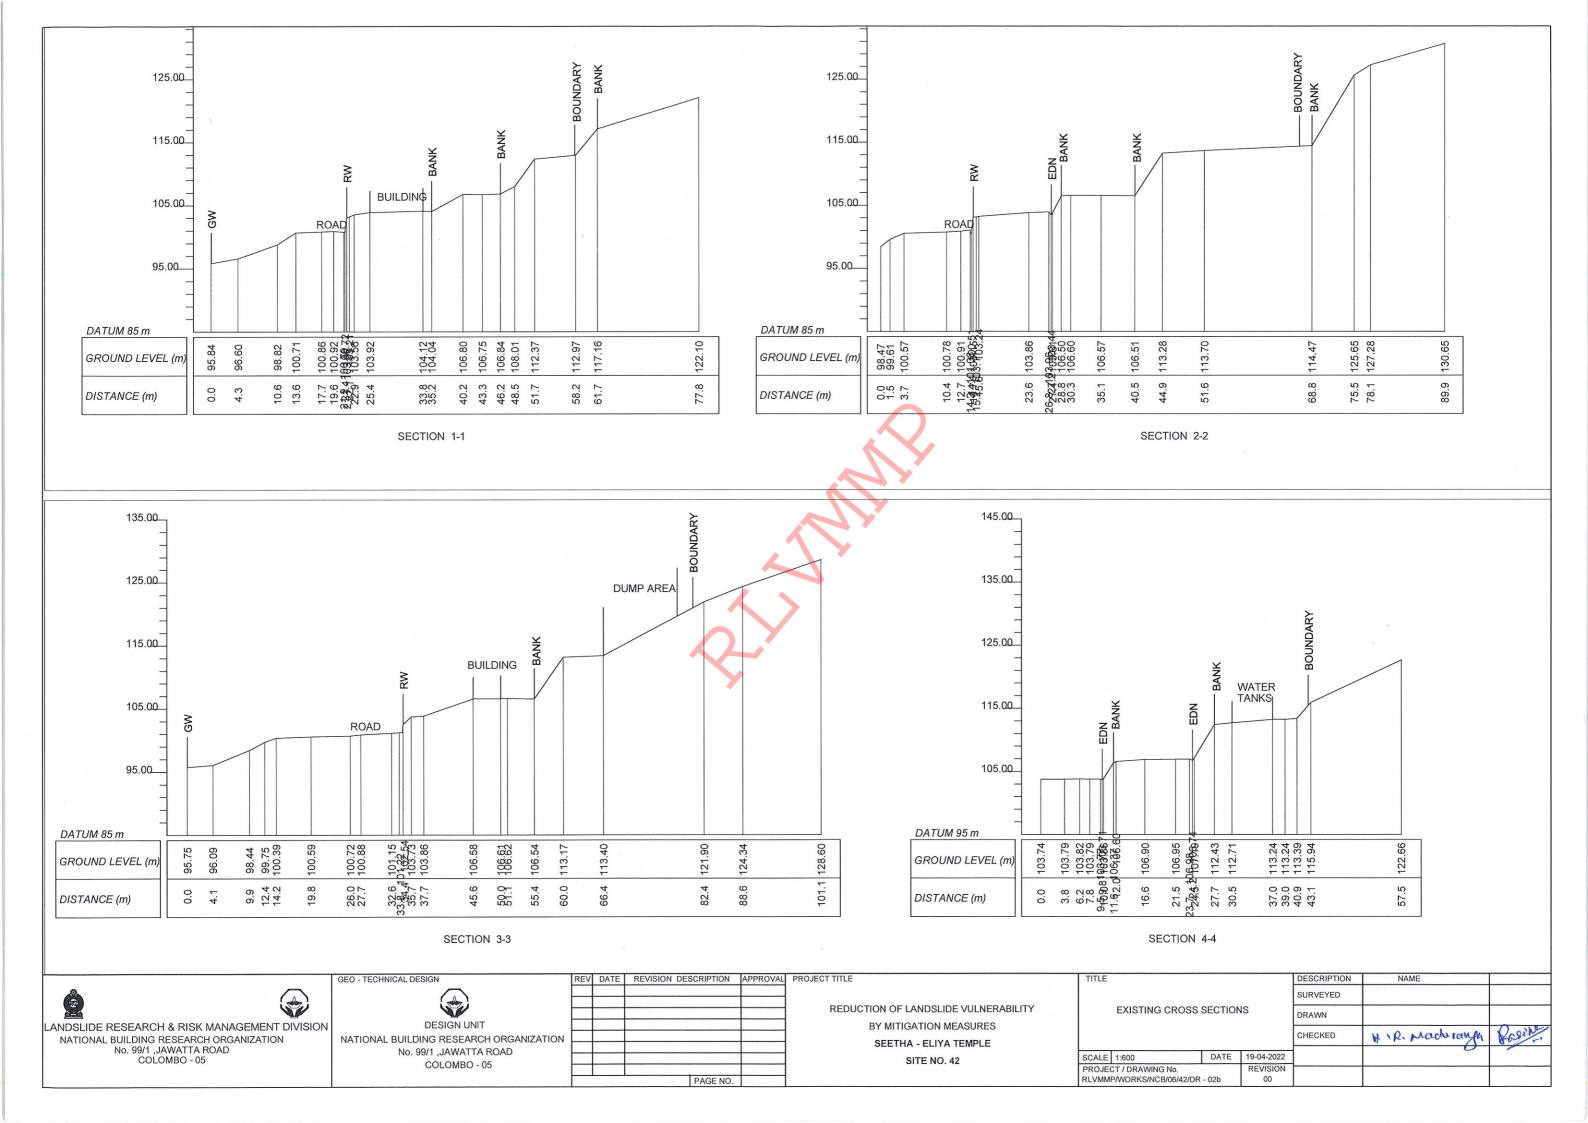

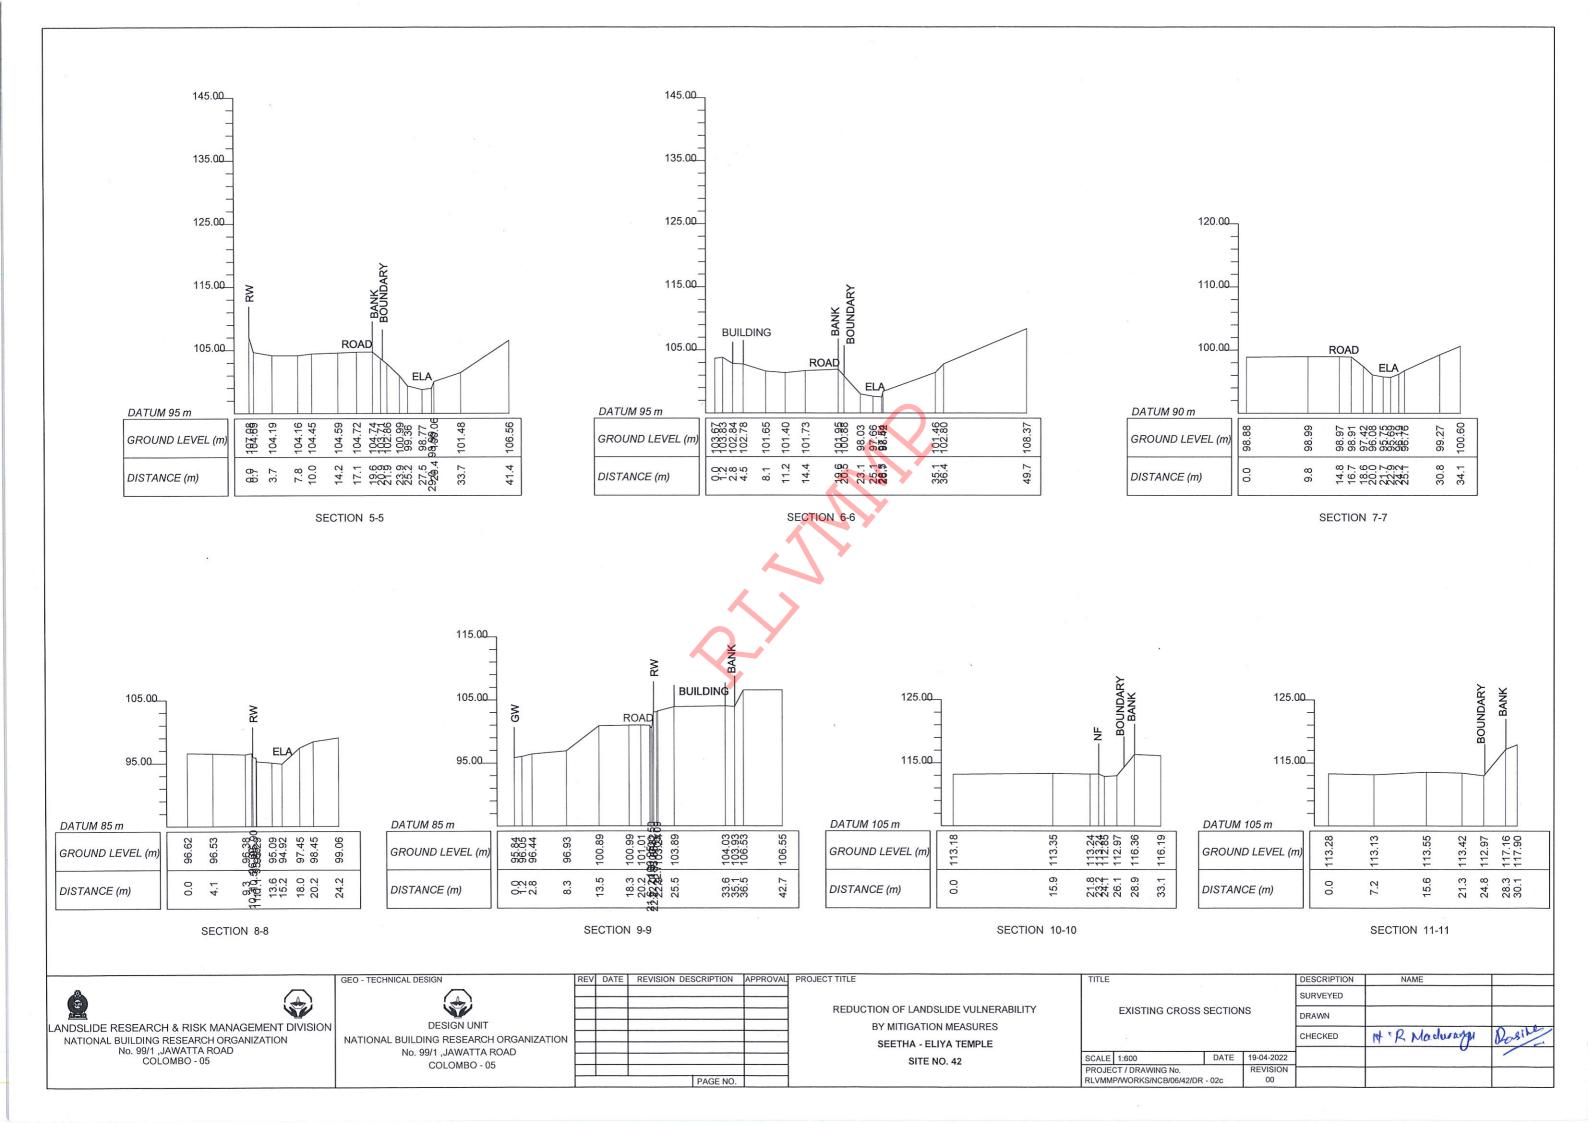

# Site No.43




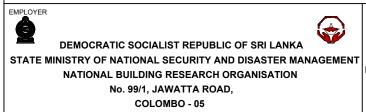



DESIGNER	(
	DESIGN UNIT
NATIONAL	<b>BUILDING RESEARCH ORGANIZATION</b>
	No. 99/1, JAWATTA ROAD,
	COLOMBO AF


7		
REDUCTION OF LANDSLIDE		
VULNERABILITY BY MITIGATION MEASURES		
]		
BOSCO COLLEGE - HATTON		

	TITLE			DESCRIPTION	NAME	SIGNATURE
	SURVEY PLAN VIEW			CHECKED	D.M.D.T. DASANAYAKA	
	SCALE 1:750	DATE	11.05.2022			
	PROJECT / DRAWING No. REVISION					
RLVMMP/WORKS/NCB/PHII/043-BO/DR-01 00						

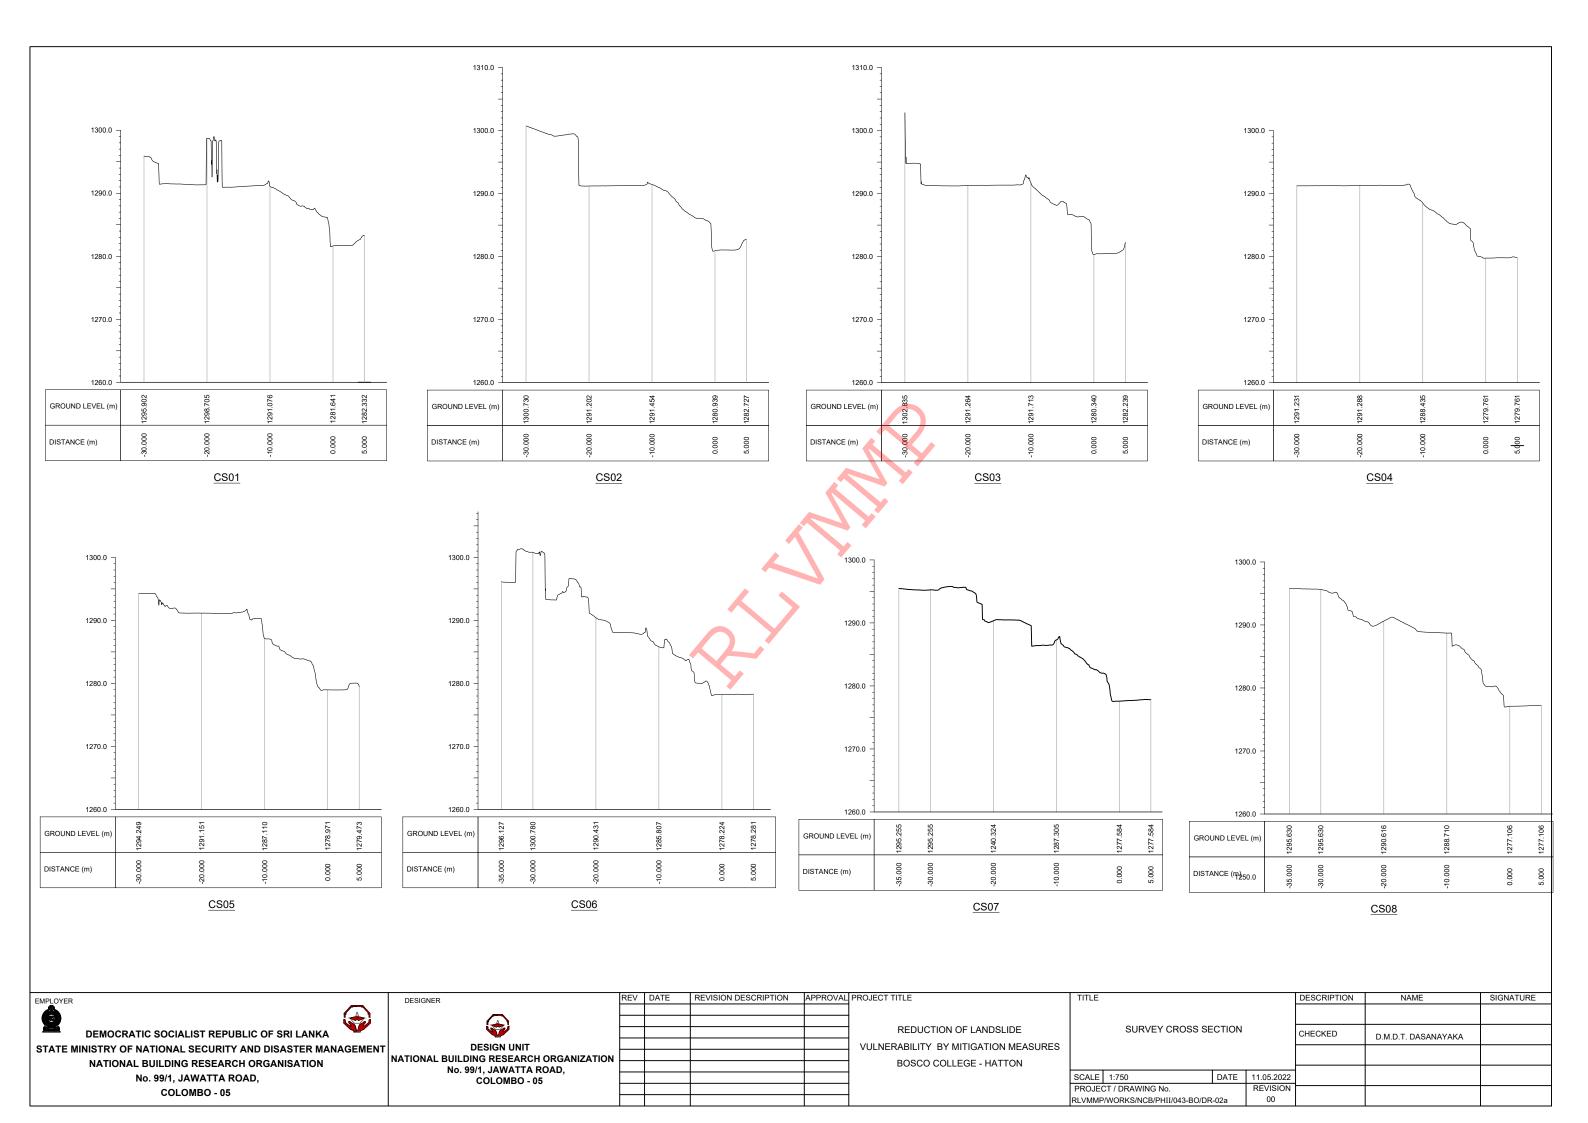

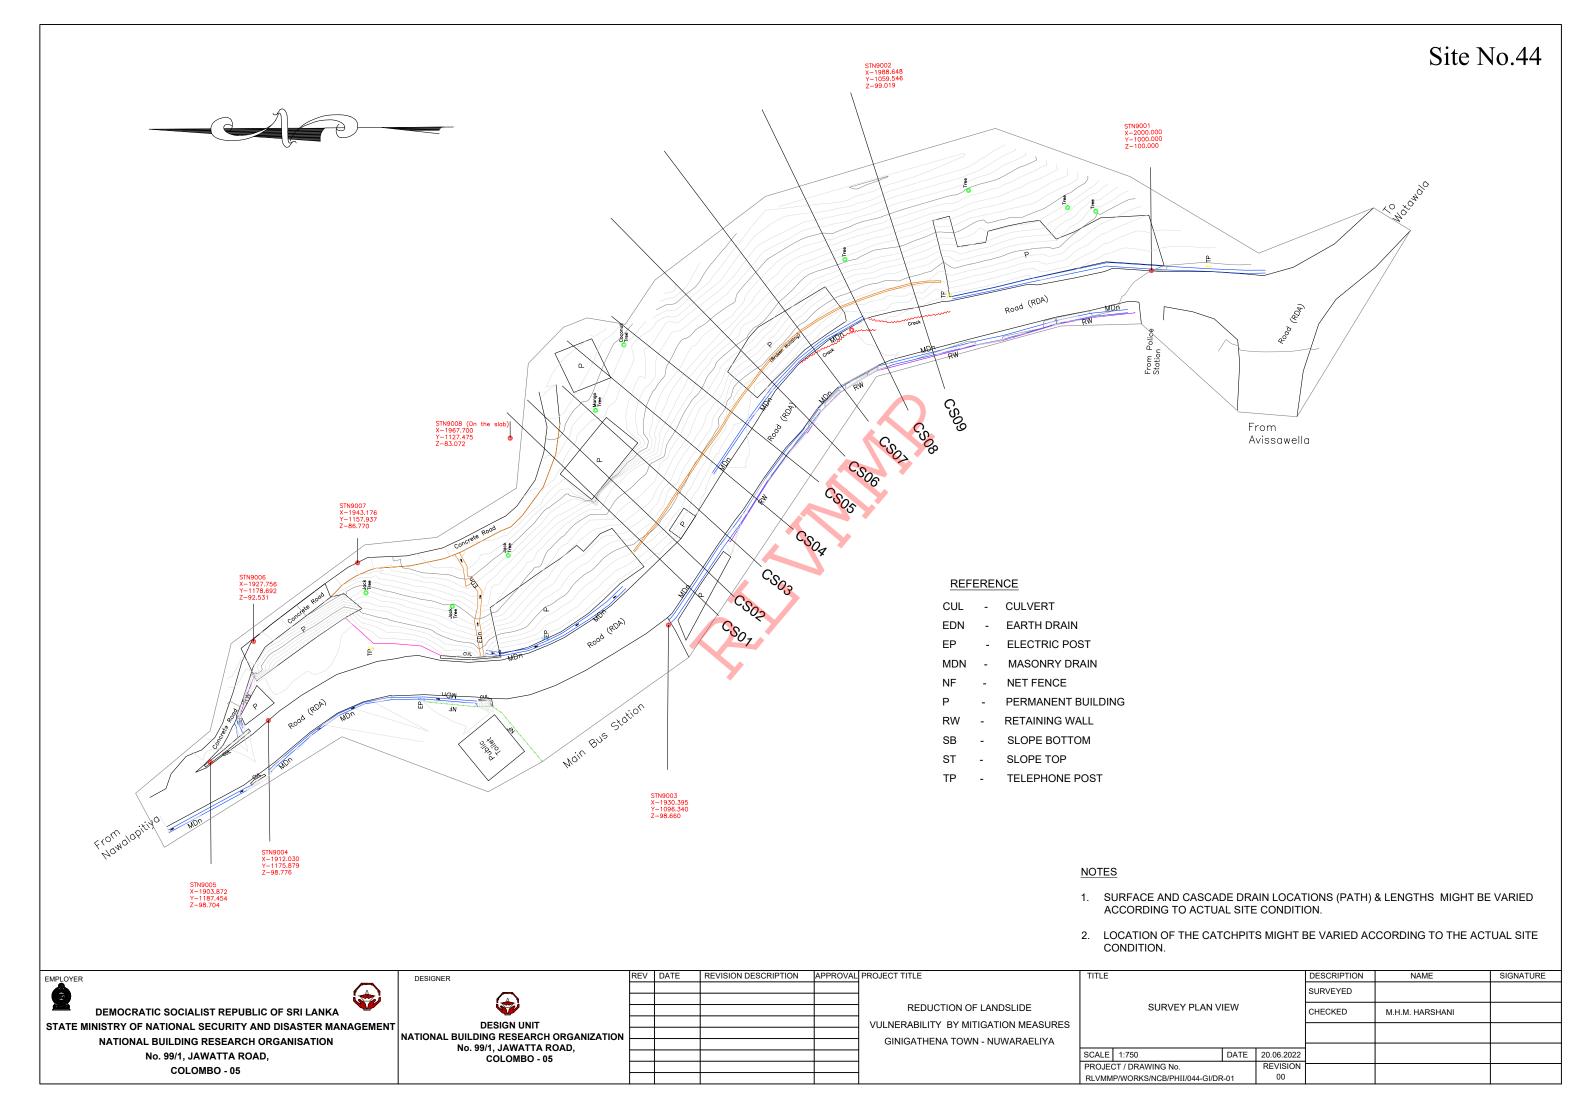

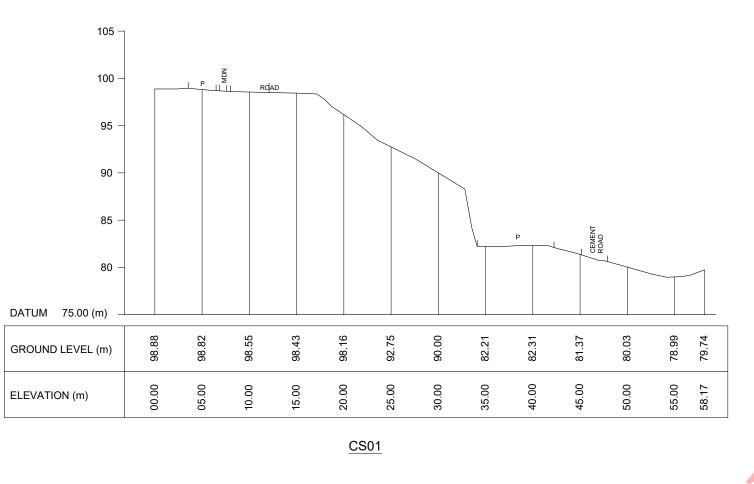

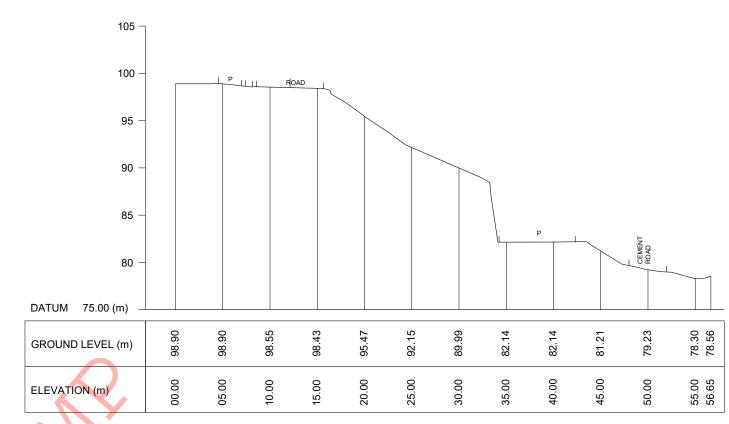

105 100 95 90 85 80 DATUM 75.00 (m) 89.60 95.93 95.60 95.29 93.11 86.89 76.01 75.21 GROUND LEVEL (m) 25.00 40.00 20.00 30.00 35.00 45.00 53.33 02.00 10.00 15.00 50.00 ELEVATION (m)

105 100 95 90 85 80 DATUM 75.00 (m) 99.62 98.98 97.56 90.20 86.35 83.80 81.56 9 99.22 98.61 GROUND LEVEL (m) 78. 02.00 20.00 30.00 35.00 40.00 45.00 50.00 55.00 10.00 15.00 ELEVATION (m)

<u>CS03</u>


REVISION DESCRIPTION | APPROVAL PROJECT TITLE

DEMOCRATIC SOCIALIST REPUBLIC OF SRI LANKA
STATE MINISTRY OF NATIONAL SECURITY AND DISASTER MANAGEMENT
NATIONAL BUILDING RESEARCH ORGANISATION
No. 99/1, JAWATTA ROAD,
COLOMBO - 05

DESIGN UNIT
NATIONAL BUILDING RESEARCH ORGANIZATION
No. 99/1, JAWATTA ROAD,
COLOMBO - 05

REDUCTION OF LANDSLIDE
VULNERABILITY BY MITIGATION MEASURES
GINIGATHENA TOWN - NUWARAELIYA

	TITLE				DESCRIPTION	NAME	SIGNATURE
	SLIDVEY CROSS SECTION			SURVEYED			
				CHECKED	M.H.M. HARSHANI		
	SCALE	1:500	DATE	20.06.2022			
	PROJECT / DRAWING No. RLVMMP/WORKS/NCB/PHII/044-GI/DR-02a 00						
				1			
				00			

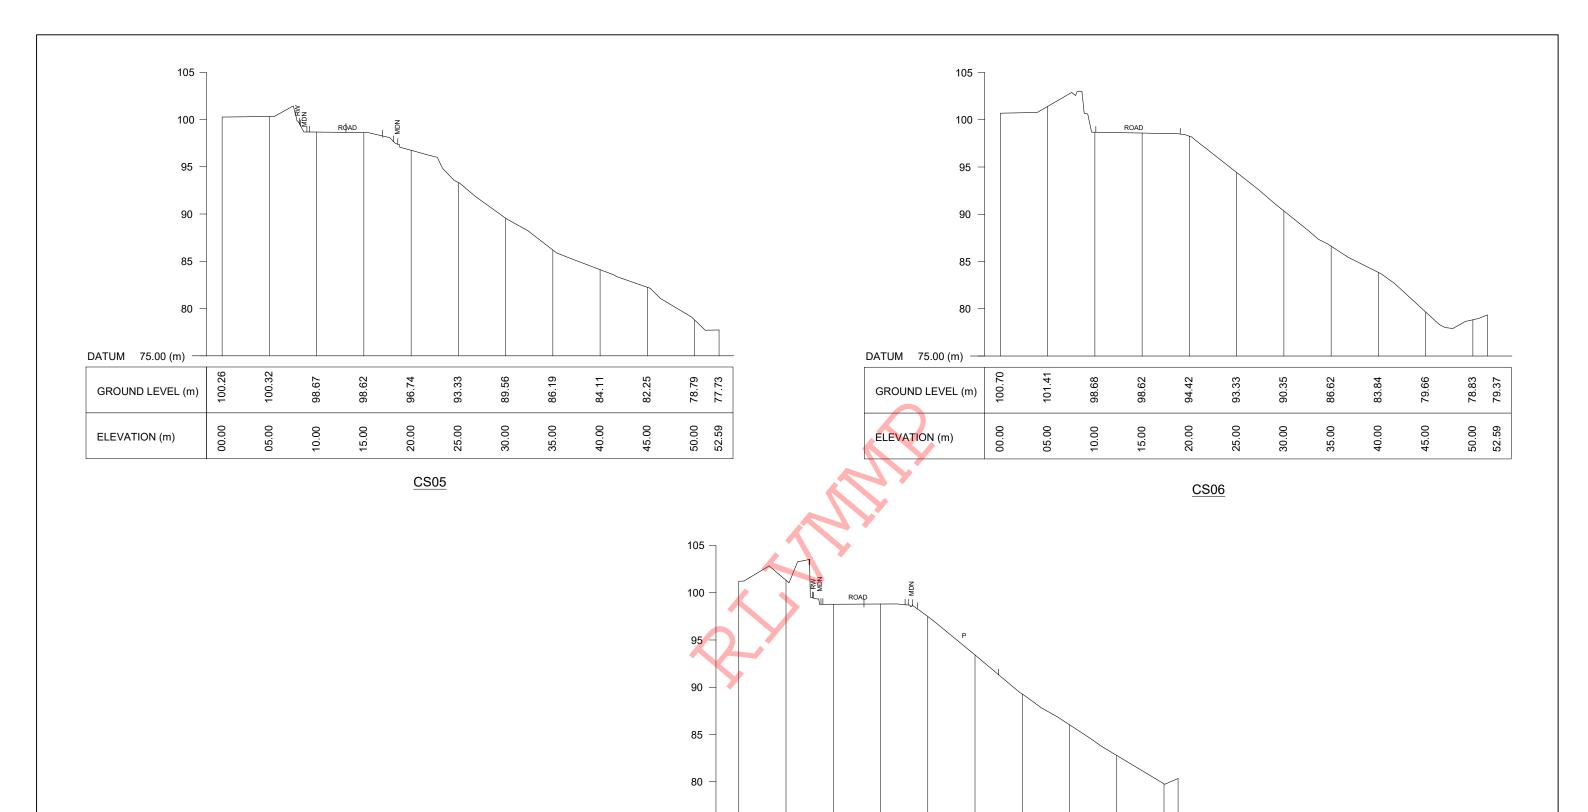

98.78

15.00

DEMOCRATIC SOCIALIST REPUBLIC OF SRI LANKA
STATE MINISTRY OF NATIONAL SECURITY AND DISASTER MANAGEMENT
NATIONAL BUILDING RESEARCH ORGANISATION
No. 99/1, JAWATTA ROAD,
COLOMBO - 05

DESIGN UNIT
NATIONAL BUILDING RESEARCH ORGANIZATION
No. 99/1, JAWATTA ROAD,
COLOMBO - 05

DATUM 75.00 (m)

GROUND LEVEL (m)

ELEVATION (m)

101.22

101.32

02.00

REV DATE REVISION DESCRIPTION APPROVAL PROJECT TITLE

		REDUCTION OF LANDSLIDE
		VULNERABILITY BY MITIGATION MEASURES
		GINIGATHENA TOWN - NUWARAELIYA

10.00

TITLI				DESCRIPTION	NAME	SIGNATURE
	SURVEY CROSS SECTION			SURVEYED		
				CHECKED	M.H.M. HARSHANI	
SCAL	E 1:500	DATE	20.06.2022			
PROJ	PROJECT / DRAWING No. REVISION RLVMMP/WORKS/NCB/PHII/044-GI/DR-02b 00					
RLVM						


79.77 80.34


45.00 46.49

82.78

40.00

35.00

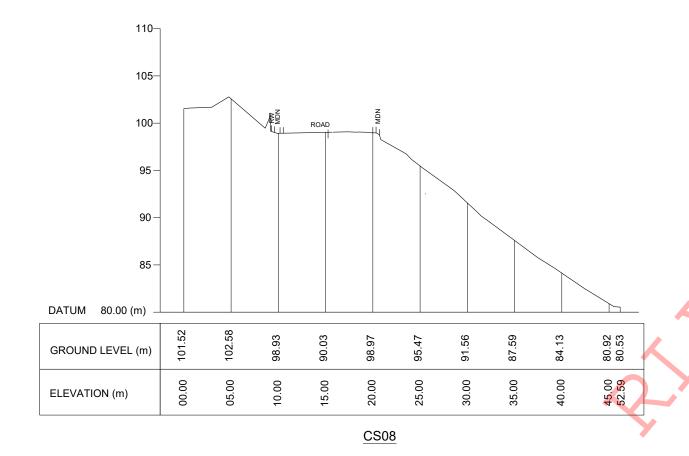

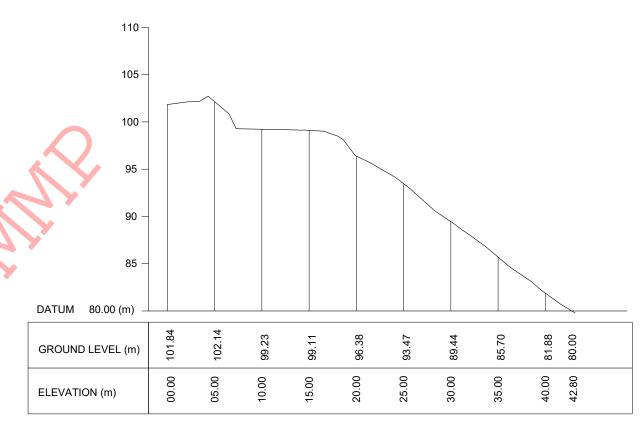


EMPLOYER	DESIGNER
DEMOCRATIC SOCIALIST REPUBLIC OF SRI LANKA	
STATE MINISTRY OF NATIONAL SECURITY AND DISASTER MANAGEMENT	
NATIONAL BUILDING RESEARCH ORGANISATION	NATIONAL B
No. 99/1, JAWATTA ROAD,	İ '
COLOMBO - 05	

DESIGN UNIT	Ľ
NATIONAL BUILDING RESEARCH ORGANIZATION	L
No. 99/1, JAWATTA ROAD,	L
COLOMBO - 05	L
302320	E
	г

REDUCTION OF LANDSLIDE
VULNERABILITY BY MITIGATION MEASURES
GINIGATHENA TOWN - NUWARAELIYA

REVISION DESCRIPTION | APPROVAL PROJECT TITLE

	TITLE				DESCRIPTION	NAME	SIGNATURE
	SUBVEY CROSS SECTION				SURVEYED		
					CHECKED	M.H.M. HARSHANI	
	SCALE	1:500	DATE	20.06.2022			
	PROJECT / DRAWING No.         REVISION           RLVMMP/WORKS/NCB/PHII/044-GI/DR-02c         00						
				00			

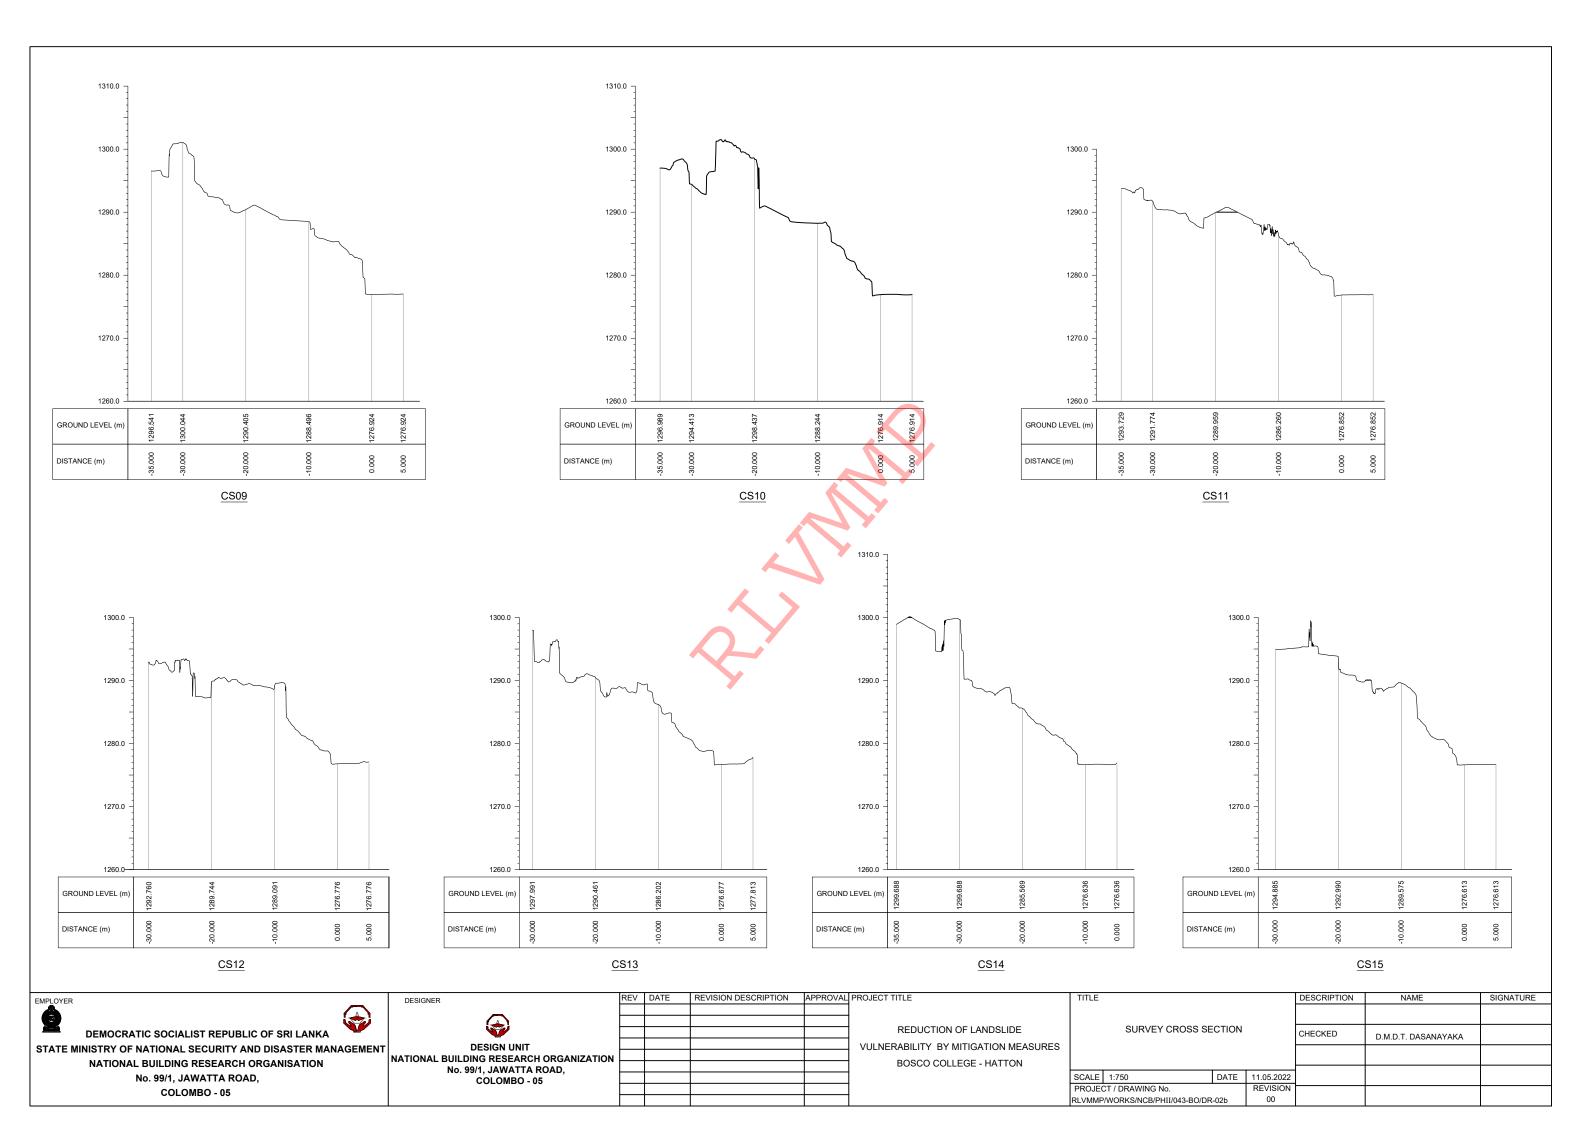





DEMOCRATIC SOCIALIST REPUBLIC OF SRI LANKA
STATE MINISTRY OF NATIONAL SECURITY AND DISASTER MANAGEMENT
NATIONAL BUILDING RESEARCH ORGANISATION
No. 99/1, JAWATTA ROAD,
COLOMBO - 05

DESIGNER

DESIGN UNIT

NATIONAL BUILDING RESEARCH ORGANIZATION

No. 99/1, JAWATTA ROAD,

COLOMBO - 05

REDUCTION OF LANDSLIDE


VULNERABILITY BY MITIGATION MEASURES


SRI SADDHARMARAMAYA TEMPLE

ROAD,


THALAWAKELE

	TITLE			DESCRIPTION	NAME	SIGNATURE
				SURVEYED		
	SURVEY PLAN V	IEW		CHECKED	V. G. D. GANGANI	
	00415 4500	DATE	17.05.2022			
	SCALE 1:500	DATE				
	PROJECT / DRAWING No.		REVISION			
	RLVMMP/WORKS/NCB/PHII/101-TK/DF	R-01	00			

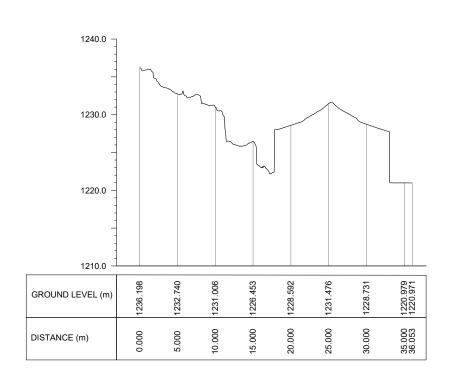


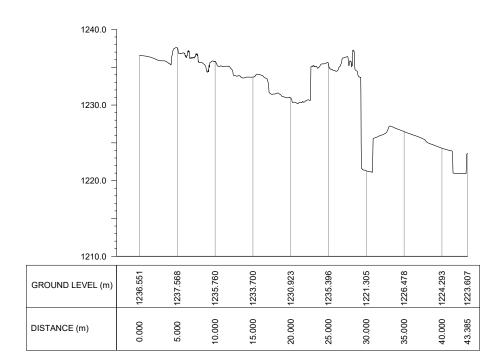

CS03

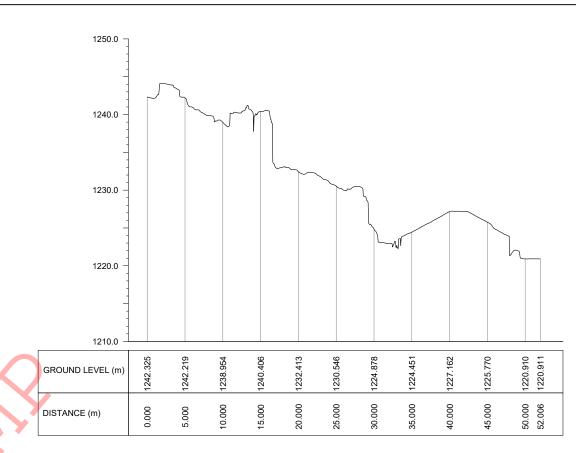

CS02

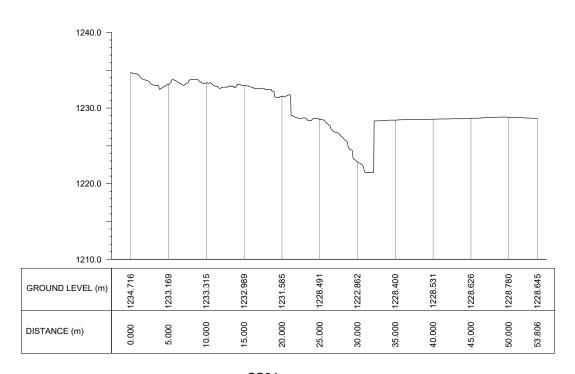

CS04

DEMOCRATIC SOCIALIST REPUBLIC OF SRI LANKA
STATE MINISTRY OF NATIONAL SECURITY AND DISASTER MANAGEMENT
NATIONAL BUILDING RESEARCH ORGANISATION
No. 99/1, JAWATTA ROAD,
COLOMBO - 05

DESIGNER

DESIGN UNIT
NATIONAL BUILDING RESEARCH ORGANIZATION
No. 99/1, JAWATTA ROAD,
COLOMBO - 05

	REV	DATE	REVISION DESCRIPTION	APPROVAL	PROJECT TITLE
					REDI
					VULNERABILI
					VULNERABILI
NC					SRI SAD

REDUCTION OF LANDSLIDE


VULNERABILITY BY MITIGATION MEASURES

SRI SADDHARMARAMAYA TEMPLE

THALAWAKELE

TITLE				DESCRIPTION	NAME	SIGNATURE
CUDVEY CROSS SECTION				SURVEYED		
				CHECKED	V. G. D. GANGANI	
SCALE	1:500	DATE	17.05.2022			
PROJE	PROJECT / DRAWING No. REVISION					
RLVMM	P/WORKS/NCB/PHII/101-TK/DF	R-02	00			

# Site No.103

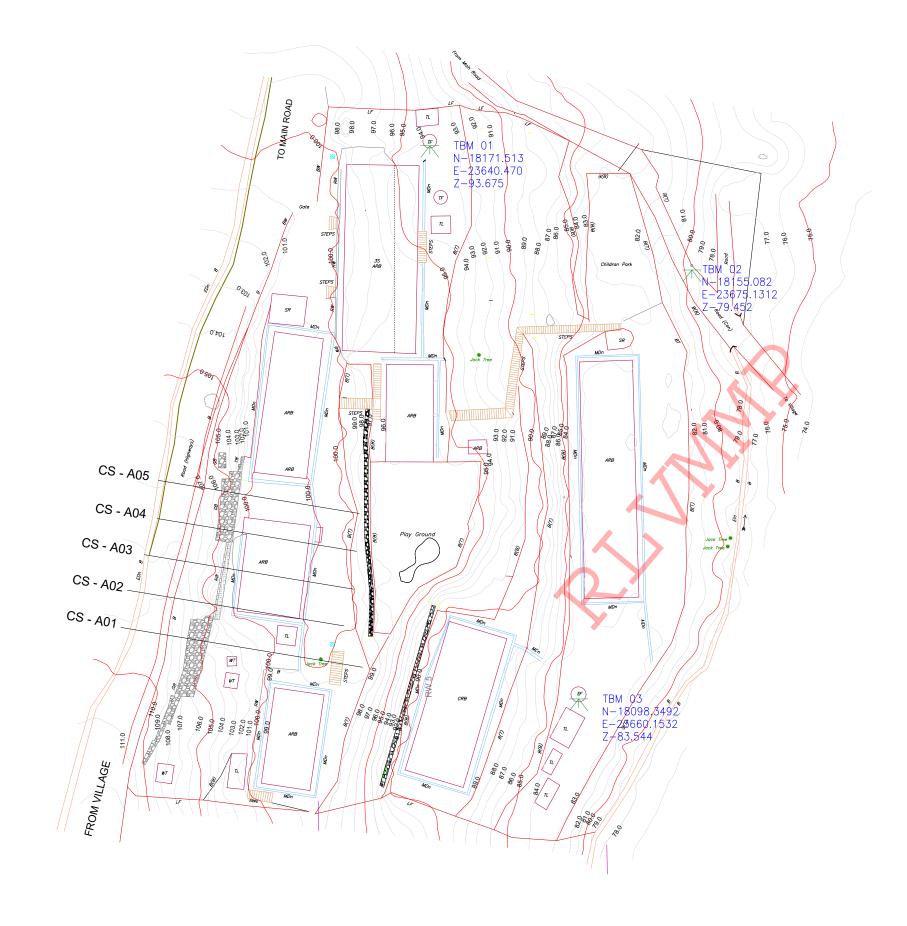

# REFERENCE

G	GATE
TF	TOILET FIT
TL	TOILET
LF	LIVE FENCE
В	BANK
B(B)	BANK BOTAM
B(T)	BANK TOP
BW	<b>BOUNDARY WALL</b>
WF	WIRE FENCE
GB	GABIAN WALL
RW	RETAINING WALL
TW	TOE WALL

TBM TEMPORARY BENCH MARK SRINE ROOM

SR MDN MASONRY DRAIN

ARB ASBESTOS ROOFED BUILDING CRB CONCRETE ROOFED BUILDING

3SARB THREE STORIED ASBESTOS ROOFED BUILDING


EMPLOYER DEMOCRATIC SOCIALIST REPUBLIC OF SRI LANKA STATE MINISTRY OF NATIONAL SECURITY AND DISASTER MANAGEMENT NATIONAL BUILDING RESEARCH ORGANISATION No. 99/1, JAWATTA ROAD,

COLOMBO - 05

	DESIGNER	ŀ
	_	L
_	DESIGN UNIT	Г
•		Г
	NATIONAL BUILDING RESEARCH ORGANIZATION	$\vdash$
	No. 99/1, JAWATTA ROAD,	L
	COLOMBO - 05	

	REDUCTION OF LANDSLIDE					
	VULNERABILITY BY MITIGATION MEASURES					
	LIYANWALA - MUNWATTA					

TITLE	ITLE			DESCRIPTION	NAME	SIGNATURE
				SURVEYED	K.G.C.KULAWANSA	
	SURVEY PLAN VIEW			CHECKED	D.M.D.T. DASANAYAKA	
SCALE	1:500	DATE	15.05.2015			
PROJECT / DRAWING No. REVISION						
RLVMMP/WORKS/NCB/PHII/103-LI/DR-01 00						

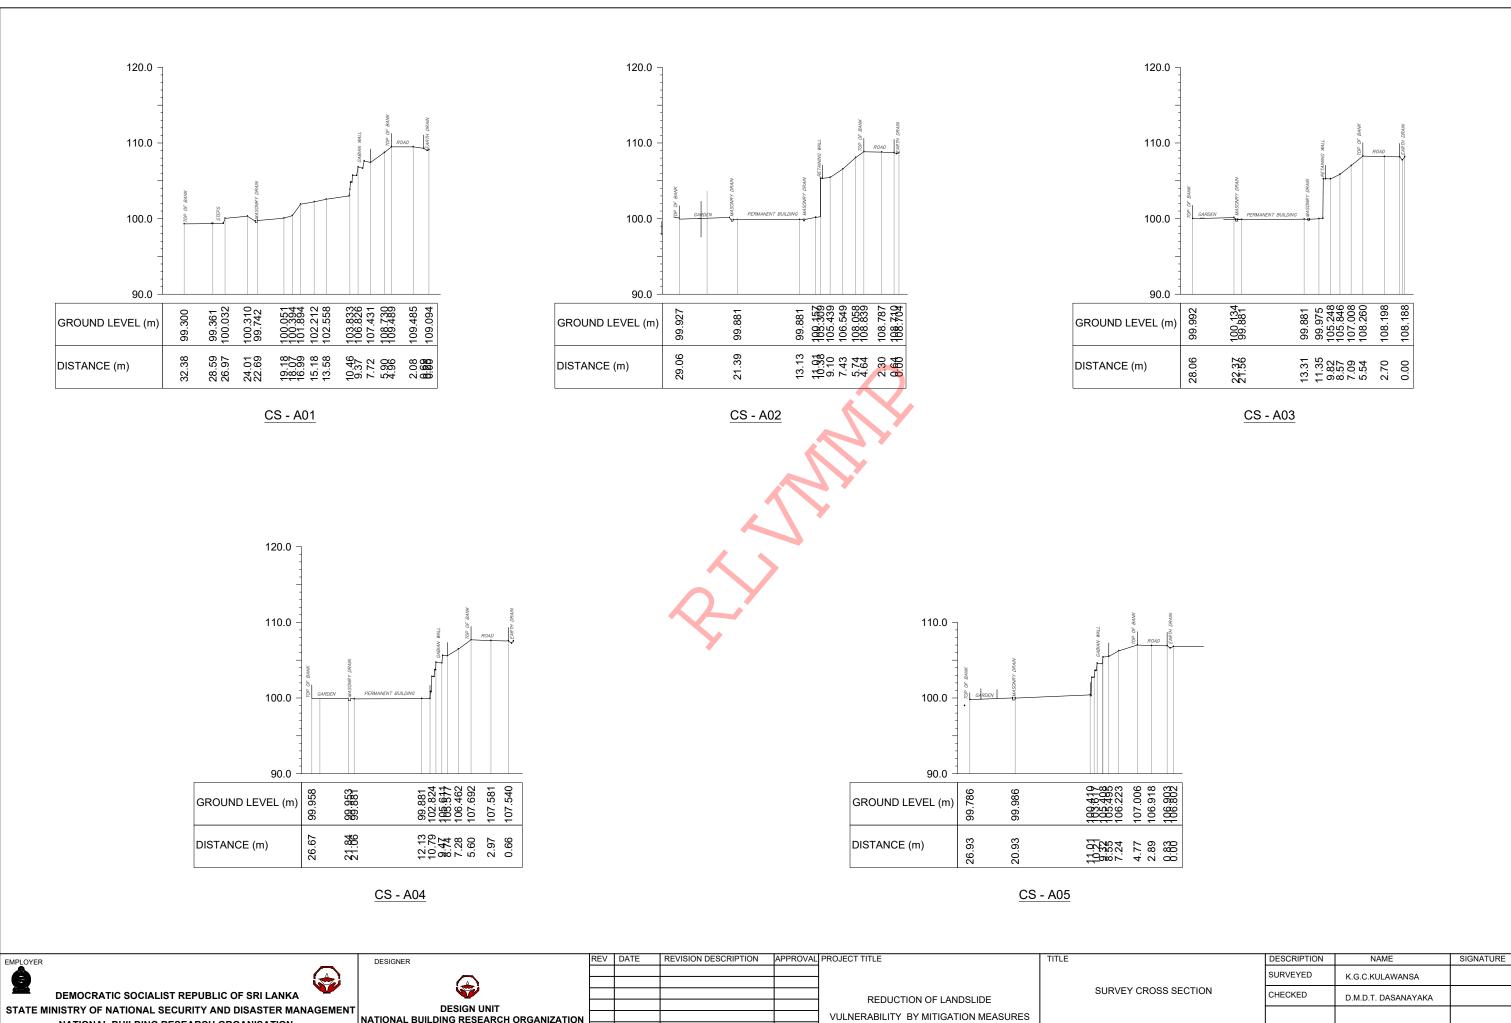

NATIONAL BUILDING RESEARCH ORGANISATION No. 99/1, JAWATTA ROAD, COLOMBO - 05

DESIGN UNIT
NATIONAL BUILDING RESEARCH ORGANIZATION No. 99/1, JAWATTA ROAD, COLOMBO - 05

LIYANWALA - MUNWATTA

				SURVEYED	K.G.C.KULAWANSA	
SURVEY CROSS SECTION			CHECKED	D.M.D.T. DASANAYAKA		
SCALE	1:750	DATE	15.05.2015			
			REVISION			
RLVMMP/WORKS/NCB/PHII/103-LI/DR-02a 00						