DEMOCRATIC SOCIALIST REPUBLIC OF SRI LANKA STATE MINISTRY OF NATIONAL SECURITY, HOME AFFAIRS & DISASTER MANAGEMENT




NATIONAL BUILDING RESEARCH ORGANISATION




REDUCTION OF LANDSLIDE VULNERABILITY BY MITIGATION MEASURES RECTIFICATION OF LANDSLIDE IN KEGALLE BY PASS

PACKAGE NO: RLVMMP/WORKS/NCB/04C

DETAILED DESIGN DRAWINGS

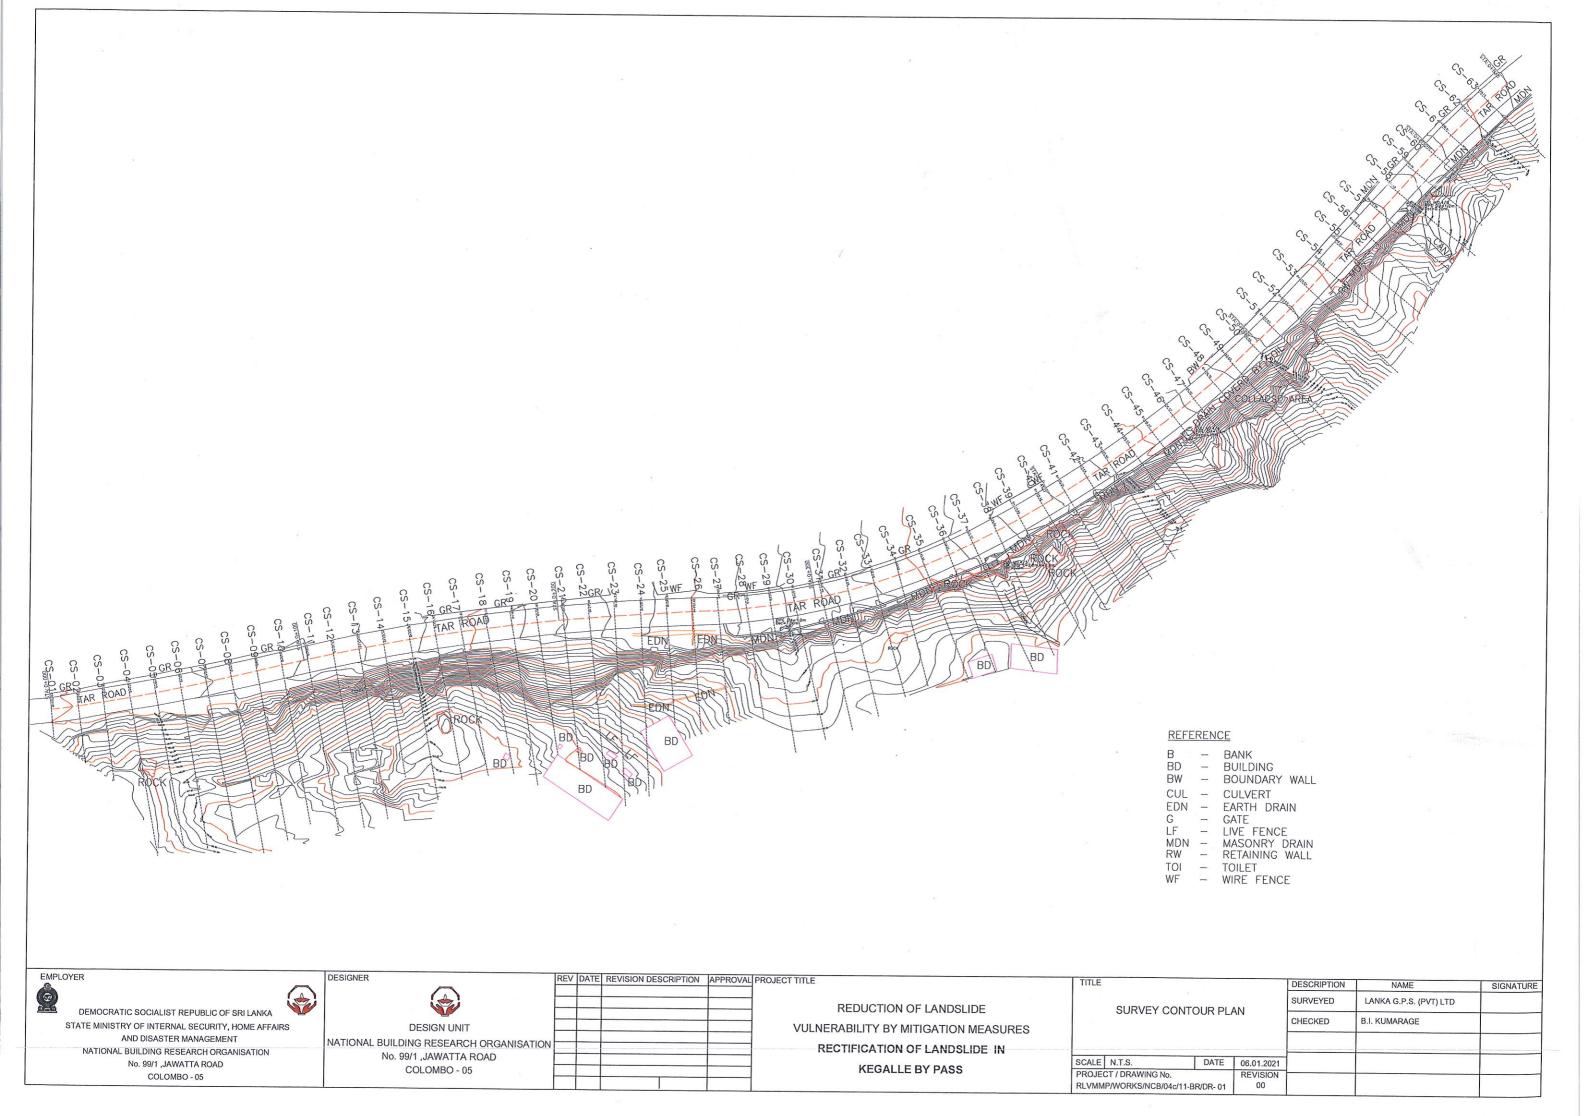

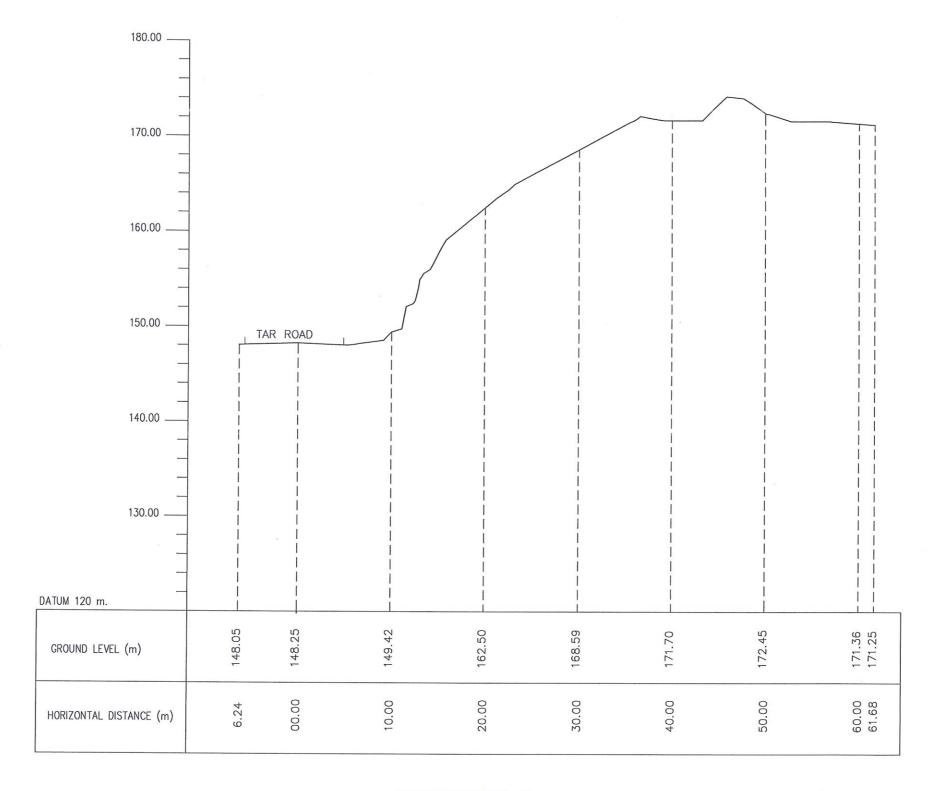

CROSS SECTION - 10

REV DATE REVISION DESCRIPTION | APPROVAL PROJECT TITLE


EMPLOYER

DEMOCRATIC SOCIALIST REPUBLIC OF SRI LANKA
STATE MINISTRY OF INTERNAL SECURITY, HOME AFFAIRS
AND DISASTER MANAGEMENT
NATIONAL BUILDING RESEARCH ORGANISATION
No. 99/1 ,JAWATTA ROAD
COLOMBO - 05

	DESIGNER	Ī
1		
	DESIGN UNIT	F
	NATIONAL BUILDING RESEARCH ORGANISATION	ŀ
	No. 99/1 ,JAWATTA ROAD	ľ
	COLOMBO - 05	

REDUCTION OF LANDSLIDE	
VULNERABILITY BY MITIGATION MEASURES	
RECTIFICATION OF LANDSLIDE IN	
KEGALLE BY PASS	
	VULNERABILITY BY MITIGATION MEASURES RECTIFICATION OF LANDSLIDE IN

TITLE				DESCRIPTION	NAME	SIGNATURE
VECALLE BY DACC				SURVEYED	LANKA G.P.S. (PVT) LTD	
	KEGALLE BY PASS CROSS SECTION			CHECKED	B.I. KUMARAGE	
		06.01.2021				
PROJECT / DRAWING No. REVISION RLVMMP/WORKS/NCB/04c/11-BR/DR- 02a 00						

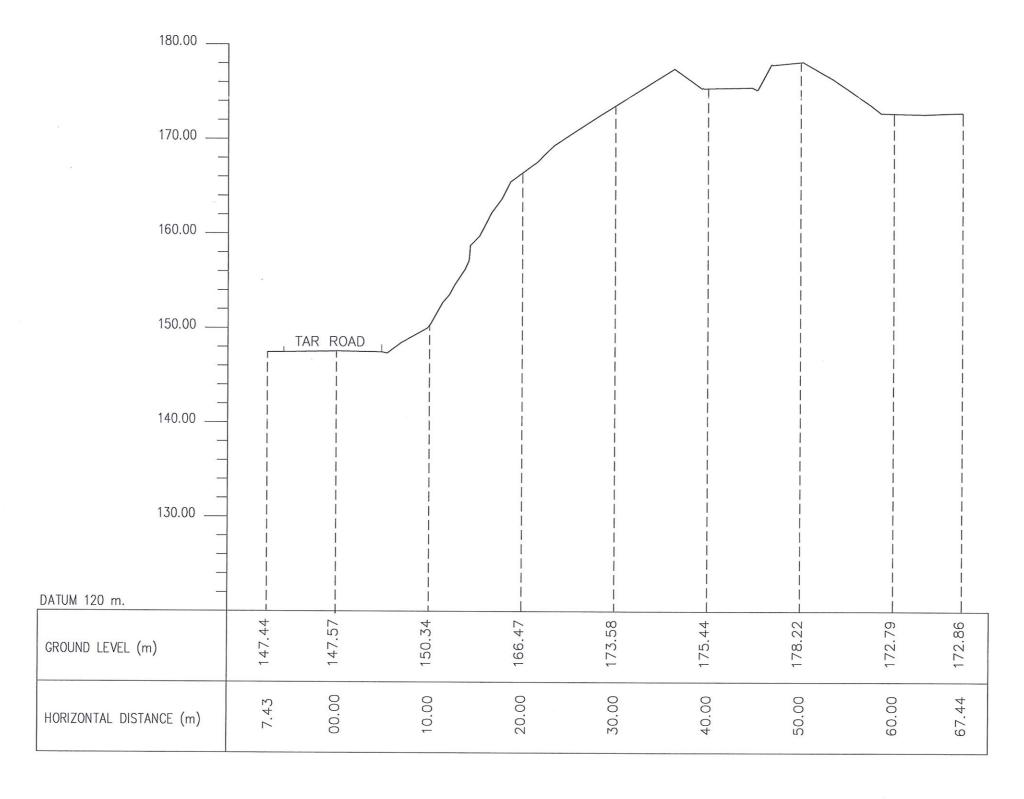

CROSS SECTION - 12

REV DATE REVISION DESCRIPTION | APPROVAL PROJECT TITLE

DEMOCRATIC SOCIALIST F

EMPLOYER


DEMOCRATIC SOCIALIST REPUBLIC OF SRI LANKA
STATE MINISTRY OF INTERNAL SECURITY, HOME AFFAIRS
AND DISASTER MANAGEMENT
NATIONAL BUILDING RESEARCH ORGANISATION
No. 99/1 ,JAWATTA ROAD
COLOMBO - 05


DESIGN UNIT
NATIONAL BUILDING RESEARCH ORGANISATION
No. 99/1 ,JAWATTA ROAD
COLOMBO - 05

DESIGNER

REDUCTION OF LANDSLIDE
VULNERABILITY BY MITIGATION MEASURES
RECTIFICATION OF LANDSLIDE IN
KEGALLE BY PASS


1	TITLE			DESCRIPTION	NAME	SIGNATURE
	KEGALLE BY	PASS		SURVEYED	LANKA G.P.S. (PVT) LTD	
	CROSS SECTION			CHECKED	B.I. KUMARAGE	
			06.01.2021			
			REVISION 00			

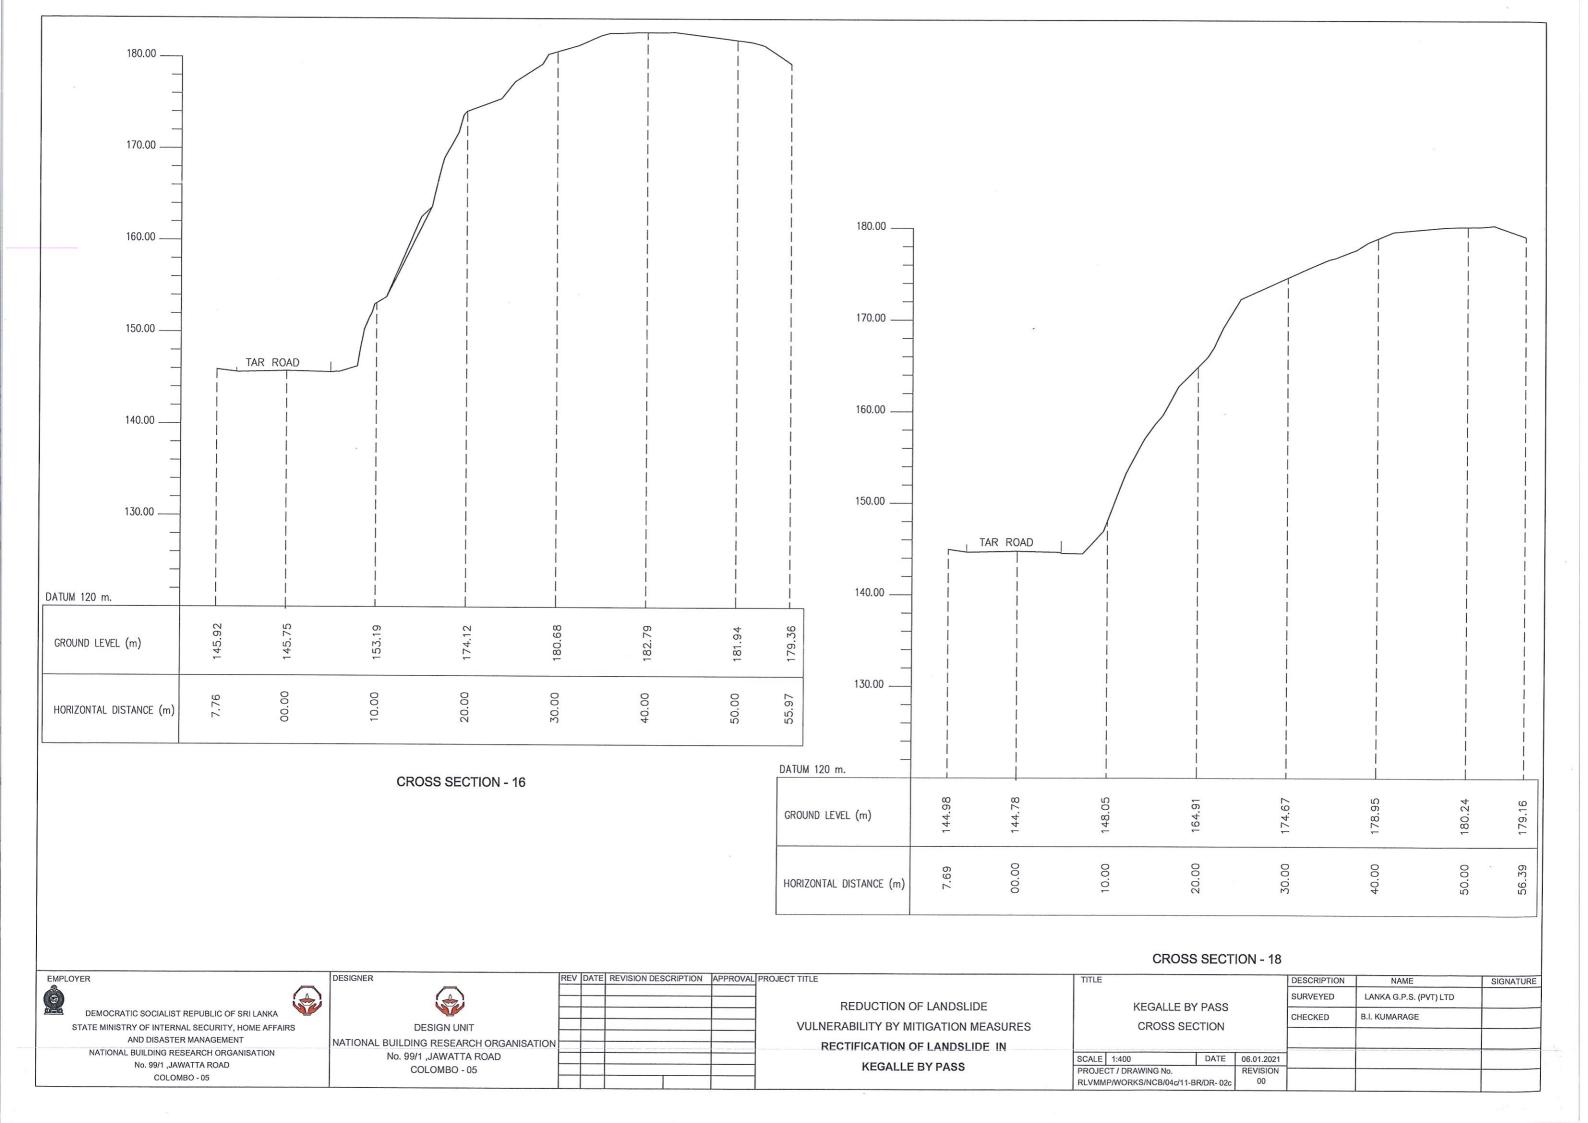

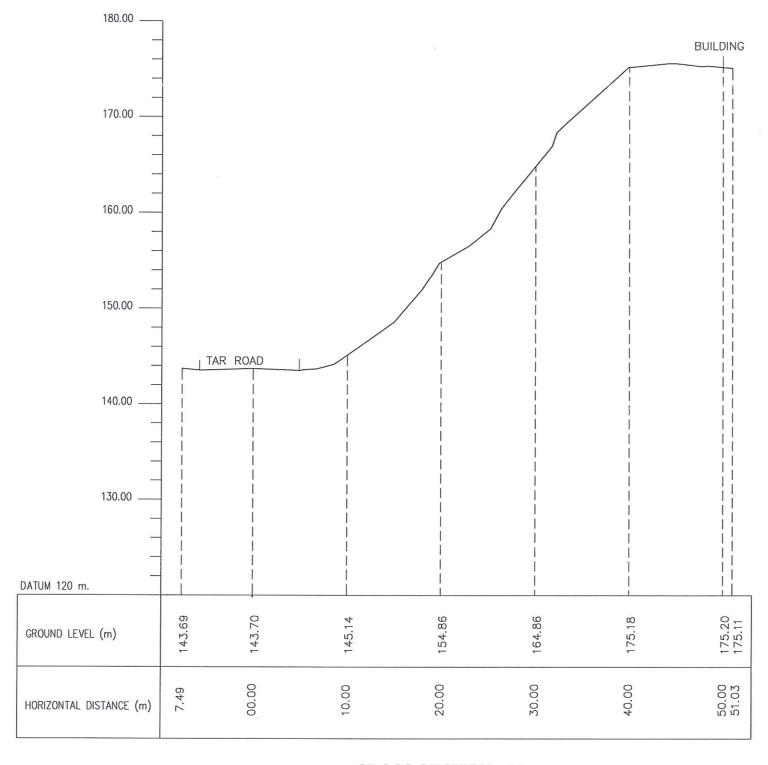

CROSS SECTION - 20

DESIGNER REV DATE REVISION DESCRIPTION APPROVAL PROJECT TITLE **EMPLOYER** DESCRIPTION NAME SIGNATURE SURVEYED LANKA G.P.S. (PVT) LTD REDUCTION OF LANDSLIDE KEGALLE BY PASS DEMOCRATIC SOCIALIST REPUBLIC OF SRI LANKA B.I. KUMARAGE **CROSS SECTION** VULNERABILITY BY MITIGATION MEASURES STATE MINISTRY OF INTERNAL SECURITY, HOME AFFAIRS **DESIGN UNIT** AND DISASTER MANAGEMENT NATIONAL BUILDING RESEARCH ORGANISATION RECTIFICATION OF LANDSLIDE IN NATIONAL BUILDING RESEARCH ORGANISATION No. 99/1 ,JAWATTA ROAD SCALE 1:400 DATE 06.01.2021 **KEGALLE BY PASS** No. 99/1 ,JAWATTA ROAD COLOMBO - 05 PROJECT / DRAWING No. REVISION COLOMBO - 05 RLVMMP/WORKS/NCB/04c/11-BR/DR-02d

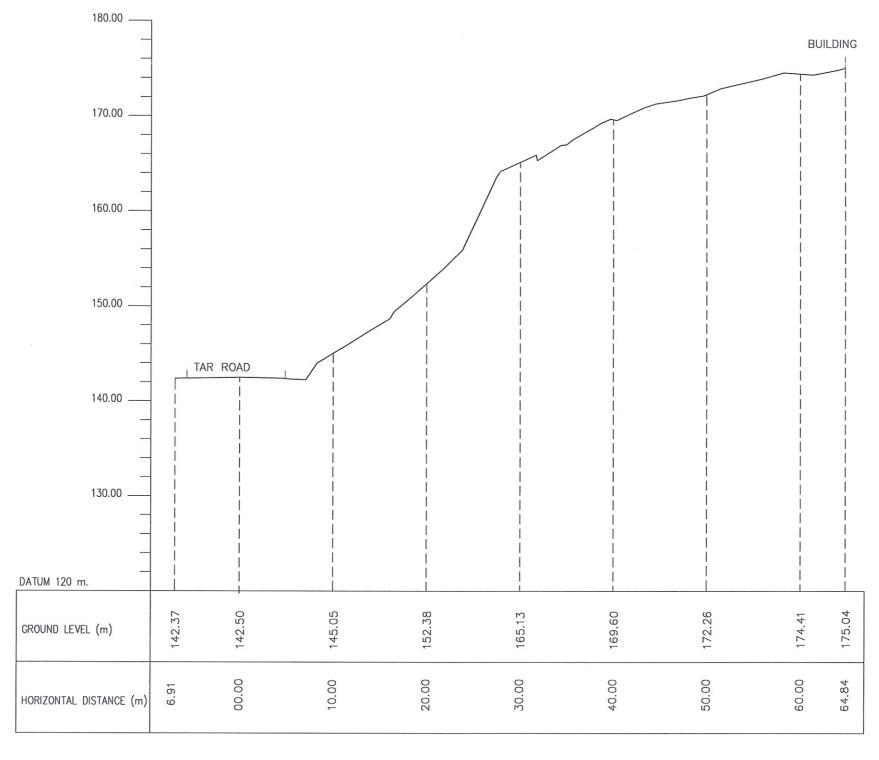


CROSS SECTION - 22


EMPLOYER DEMOCRATIC SOCIALIST REPUBLIC OF SRI LANKA STATE MINISTRY OF INTERNAL SECURITY, HOME AFFAIRS AND DISASTER MANAGEMENT NATIONAL BUILDING RESEARCH ORGANISATION No. 99/1 ,JAWATTA ROAD COLOMBO - 05

ESIGNER	REV	DATE	REVISION DESCRIPTION	APPROVAL	PROJECT TITLE
					REDUCTION OF LANDSLIDE
DESIGN UNIT					VULNERABILITY BY MITIGATION MEASURES
ATIONAL BUILDING RESEARCH ORGANISATION					RECTIFICATION OF LANDSLIDE IN
No. 99/1 ,JAWATTA ROAD COLOMBO - 05					KEGALLE BY PASS


	TITLE				DESCRIPTION	NAME	SIGNATURE
		KEGALLE	BY PASS		SURVEYED	LANKA G.P.S. (PVT) LTD	
		CROSS SECTION			CHECKED	B.I. KUMARAGE	
	SCALE	1:400	DATE	06.01.2021	1		
	PROJECT / DRAWING No. RLVMMP/WORKS/NCB/04c/11-BR/DR-02e			REVISION 00			

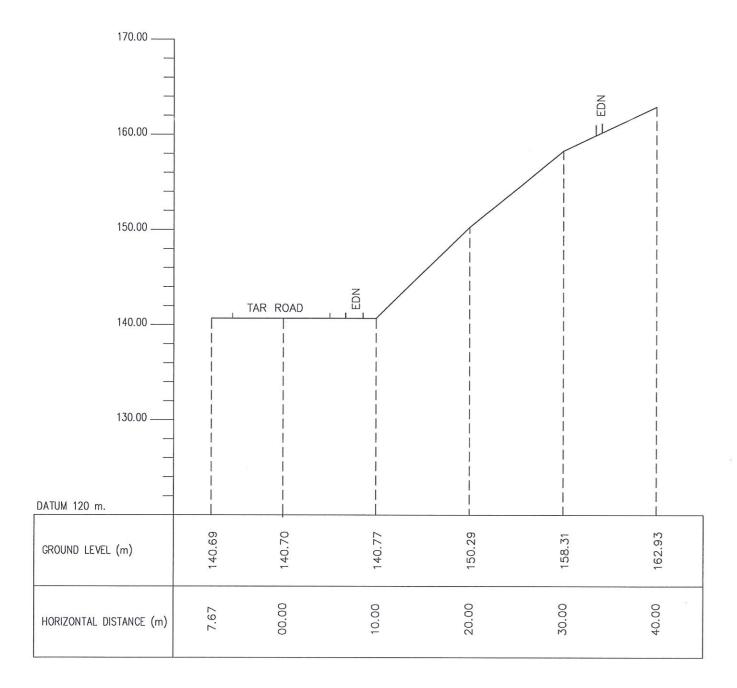


CROSS SECTION - 25

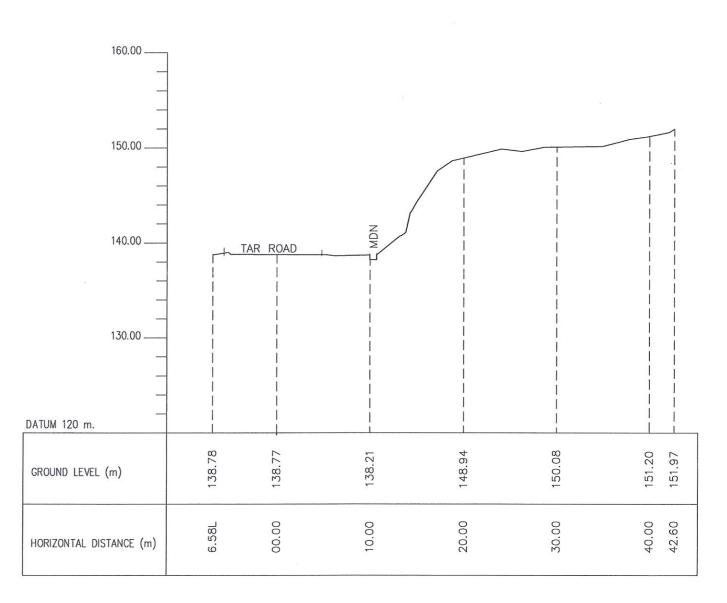


CROSS SECTION - 28

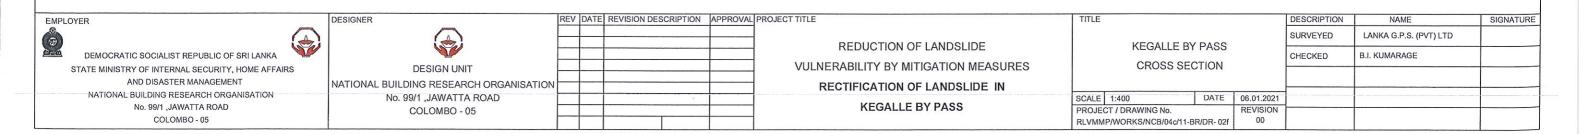

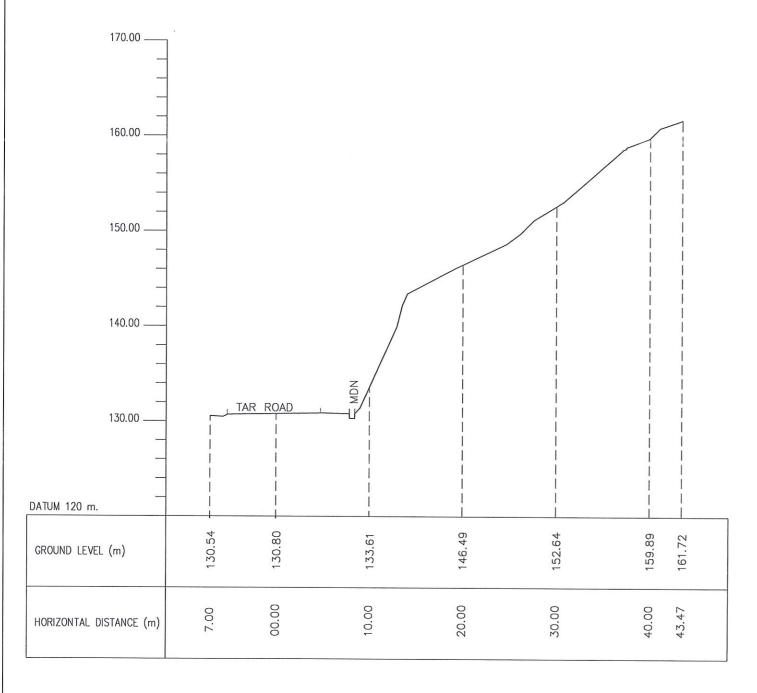

CROSS SECTION - 43

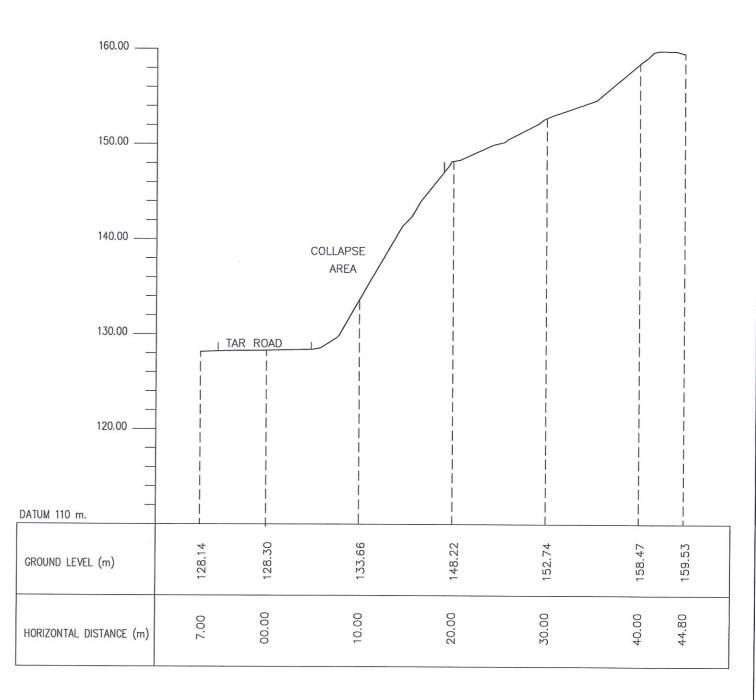

CROSS SECTION - 48

EMPLOYER

DEMOCRATIC SOCIALIST REPUBLIC OF SRI LANKA

STATE MINISTRY OF INTERNAL SECURITY, HOME AFFAIRS

AND DISASTER MANAGEMENT

NATIONAL BUILDING RESEARCH ORGANISATION

No. 99/1, JAWATTA ROAD

COLOMBO - 05

DESIGNER

DESIGN UNIT

NATIONAL BUILDING RESEARCH ORGANISATION

No. 99/1 ,JAWATTA ROAD

COLOMBO - 05

REDUCTION OF LANDSLIDE


VULNERABILITY BY MITIGATION MEASURES

RECTIFICATION OF LANDSLIDE IN

KEGALLE BY PASS

REV DATE REVISION DESCRIPTION APPROVAL PROJECT TITLE

			DESCRIPTION	NAME	SIGNATURE
KEGALLE BY	GALLE BY PASS			LANKA G.P.S. (PVT) LTD	
CROSS SEC	CTION		CHECKED	B.I. KUMARAGE	
LE 1:400 DATE 06.01.2021					
	R/DR- 02g	REVISION 00			
	CROSS SEC	CT / DRAWING No.	1:400 DATE 06.01.2021— DT / DRAWING No. REVISION	CROSS SECTION CHECKED 1:400 DATE 06.01.2021 CT / DRAWING No. REVISION	KEGALLE BY PASS CROSS SECTION SURVEYED LANKA G.P.S. (PVT) LTD CHECKED B.I. KUMARAGE T/DRAWING No. REVISION

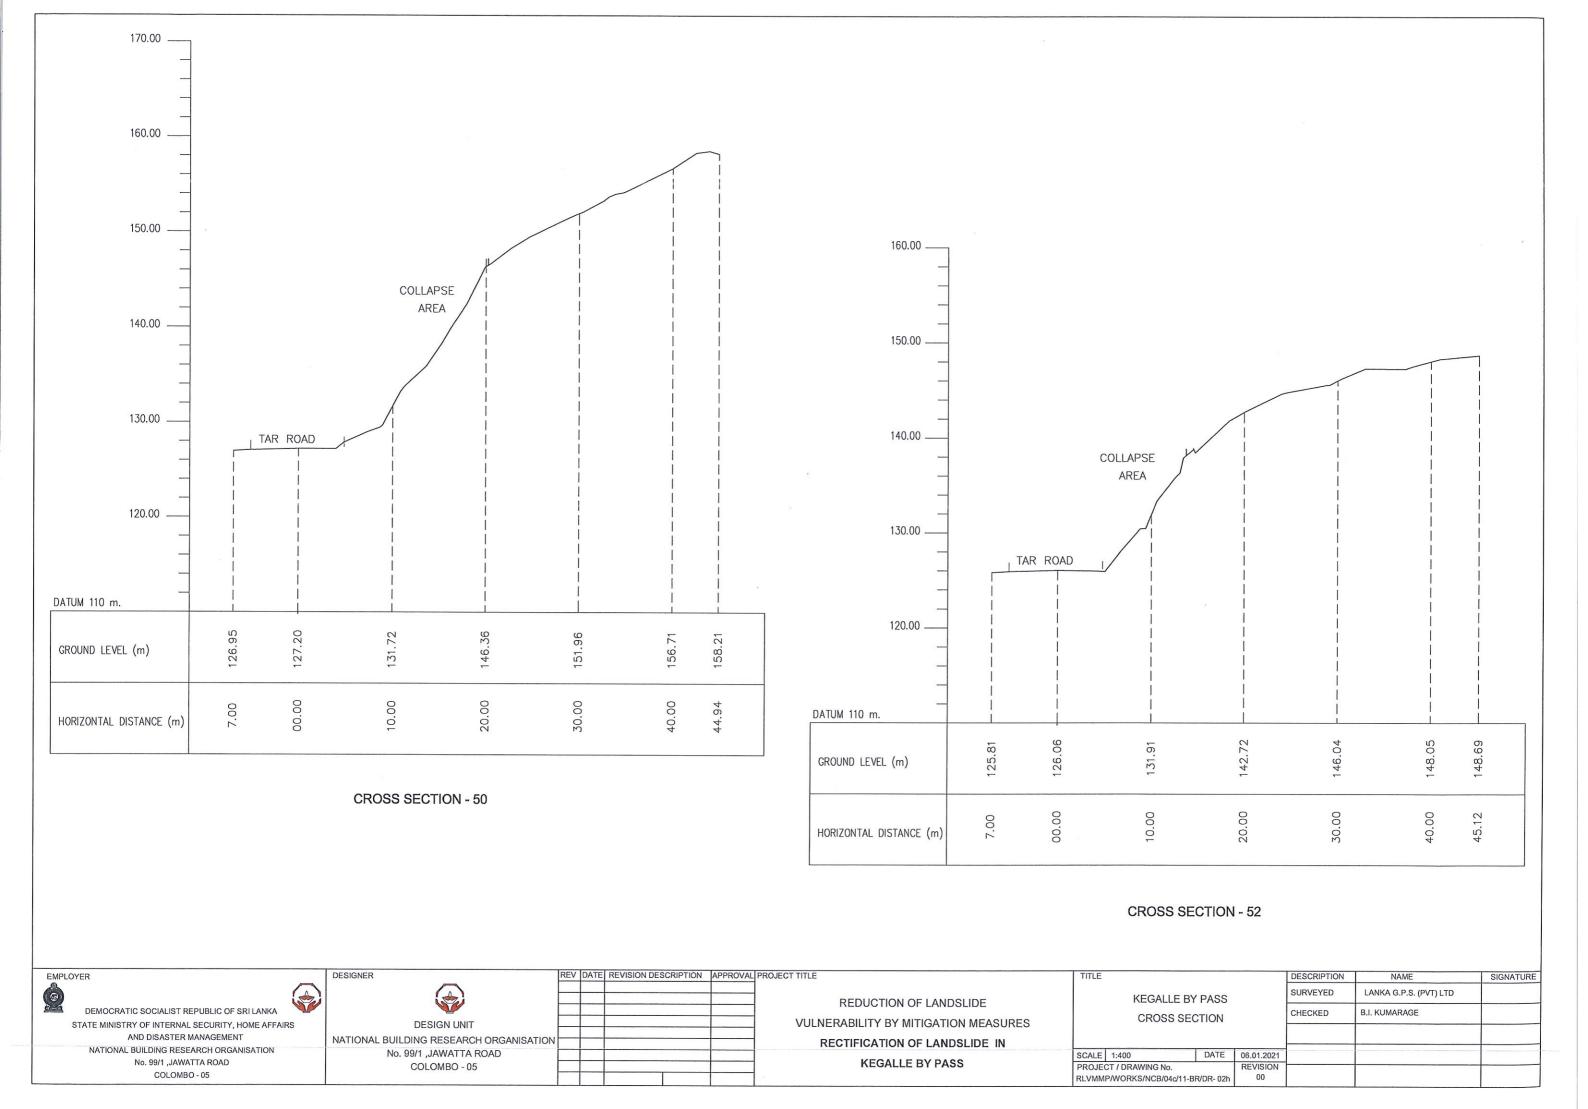

DESIGNER **DESIGN UNIT** NATIONAL BUILDING RESEARCH ORGANISATION No. 99/1 ,JAWATTA ROAD

REDUCTION OF LANDSLIDE VULNERABILITY BY MITIGATION MEASURES RECTIFICATION OF LANDSLIDE IN

SURVEYED LANKA G.P.S. (PVT) LTD KEGALLE BY PASS B.I. KUMARAGE CHECKED CROSS SECTION SCALE 1:400 DATE 06.01.2021 PROJECT / DRAWING No. RLVMMP/WORKS/NCB/04c/11-BR/DR- 02i

DESCRIPTION

NAME

SIGNATURE

CROSS SECTION - 56

REV DATE REVISION DESCRIPTION APPROVAL PROJECT TITLE

150.00 — 140.00 — 130.00 — 110		AR ROAD I I I I I I I I I I I I I I I I I I	NOW				
GROUND LEVEL (m)	123.51	123.69	126.84	136.70	138.76	137.62	
HORIZONTAL DISTANCE (m)	7.00	00.00	10.00	20.00	30.00	36.38	

EMPLOYER


STATE MINISTRY OF INTERNAL SECURITY, HOME AFFAIRS AND DISASTER MANAGEMENT NATIONAL BUILDING RESEARCH ORGANISATION No. 99/1 ,JAWATTA ROAD

DEMOCRATIC SOCIALIST REPUBLIC OF SRI LANKA COLOMBO - 05

COLOMBO - 05

KEGALLE BY PASS

- 1. LOCATION, LENGTH AND NUMBER OF SOIL NAILS MIGHT BE VARIED ACCORDING TO THE SITE CONDITION ENCOUNTERED DURING CONSTRUCTION.
- ANGLE, LOCATION, LENGTH AND NUMBER OF HORIZONTAL DRAINS MIGHT BE VARIED ACCORDING TO THE SITE CONDITION ENCOUNTERED DURING CONSTRUCTION.
- SURFACE / SUB SURFACE DRAIN LOCATIONS (PATHS) AND LENGTHS MIGHT BE VARIED ACCORDING TO THE ACTUAL SITE CONDITIONS.
- LOCATIONS OF THE CATCH PITS MIGHT BE VARIED ACCORDING TO THE ACTUAL SITE CONDITIONS.

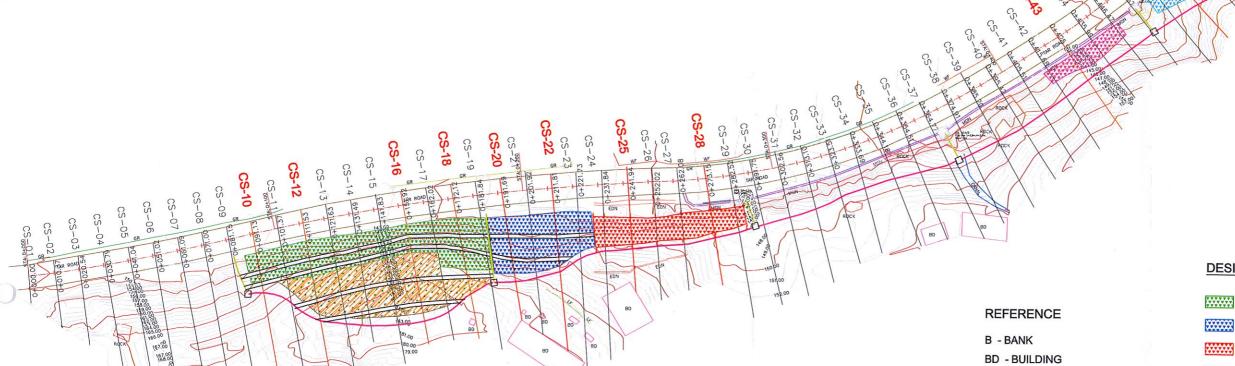

DESIGN NOTATION

- SOIL NAILING AREA 1

- SOIL NAILING AREA 2

- SOIL NAILING AREA 3

- SOIL NAILING AREA 4

- SOIL NAILING AREA 5

- EXCAVATION AND VEGETATION COVER

- DS(M) - C

- DS(C) - E

- DS(B) - C (TYPE II)

(-)

- CATCHPIT

EMPLOYER .

DEMOCRATIC SOCIALIST REPUBLIC OF SRI LANKA
STATE MINISTRY OF INTERNAL SECURITY, HOME AFFAIRS
AND DISASTER MANAGEMENT
NATIONAL BUILDING RESEARCH ORGANISATION
No. 99/1 ,JAWATTA ROAD
COLOMBO - 05

DESIGN UNIT
NATIONAL BUILDING RESEARCH ORGANISATION

No. 99/1 ,JAWATTA ROAD

COLOMBO - 05

IISATION

REDUCTION OF LANDSLIDE

VULNERABILITY BY MITIGATION MEASURES

RECTIFICATION OF LANDSLIDE IN

KEGALLE BY PASS

BW - BOUNDARY WALL

EDN - EARTH DRAIN

MDN - MASONRY DRAIN


RW - RETAINING WALL

CUL - CULVERT

G - GATE LF - LIVE FENCE


TOI -TOILET
WF - WIRE FENCE

ITLE				DESCRIPTION	NAME
	DESIGN PLAN	N VIEW		DRAWN	B.V.S. PATTRISHIYA
F PI	ROPOSED MITIGAT	TION ME	EASURES	DESIGNER	B.I. KUMARAGE
				CHECKED	J.P. SAMARANAYAKE
CALE	N.T.S.	DATE	06.01.2021	RECOMMENDED	PROF. S.A.S. KULATHILAKA
ROJE	CT / DRAWING No.		REVISION		

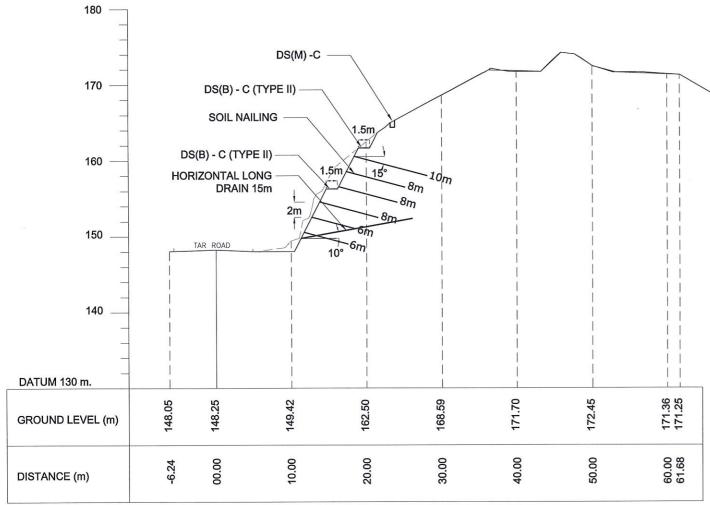



- 1. LOCATION, LENGTH AND NUMBER OF SOIL NAILS MIGHT BE VARIED ACCORDING TO THE SITE CONDITION ENCOUNTERED DURING CONSTRUCTION.
- 2. ANGLE, LOCATION, LENGTH AND NUMBER OF HORIZONTAL DRAINS MIGHT BE VARIED ACCORDING TO THE SITE CONDITION ENCOUNTERED DURING CONSTRUCTION.

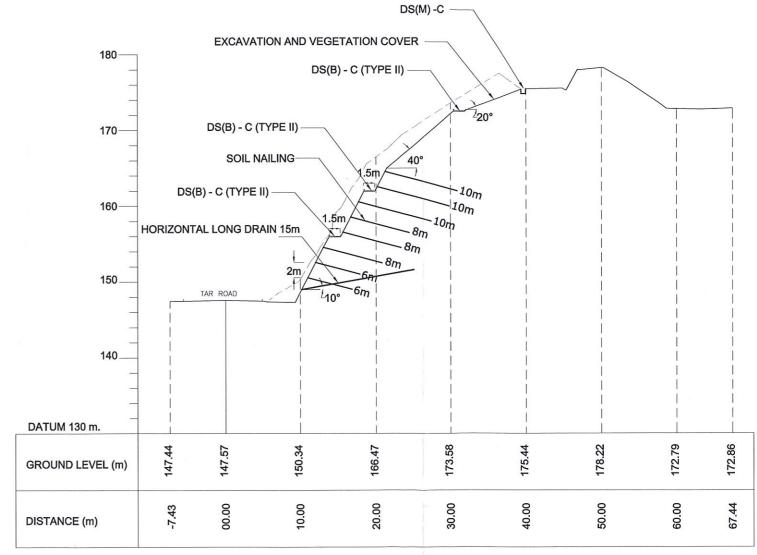

CROSS SECTION - 12


DEMOCRATIC SOCIALIST REPUBLIC OF SRI LANKA
STATE MINISTRY OF INTERNAL SECURITY, HOME AFFAIRS
AND DISASTER MANAGEMENT

ATE MINISTRY OF INTERNAL SECURITY, HOME AFFAIR
AND DISASTER MANAGEMENT
NATIONAL BUILDING RESEARCH ORGANISATION
No. 99/1 ,JAWATTA ROAD
COLOMBO - 05

DESIGNER	Ŀ
	L
	ŀ
Y	ŀ
DESIGN UNIT	ŀ
NATIONAL BUILDING RESEARCH ORGANISATION	t
No. 99/1 ,JAWATTA ROAD	
COLOMBO - 05	ı

	REV	DATE	REVISION DESCRIPTION	APPROVAL	PROJECT TITLE
	\vdash				REDUCTION (
					VULNERABILITY BY M
J					RECTIFICATION (
4				-	RECTIFICATION
	_			_	KEGALLE

TITLE	-			DESCRIPTION	NAME	SIGNATURE
	DESIGN CROSS	SECTIO	N	DRAWN	B.V.S. PATTRISHIYA	R
OF PI	ROPOSED MITIGA			DESIGNER	B.I. KUMARAGE	Short
				CHECKED	J.P. SAMARANAYAKE	hall
SCALE 1:500 DATE 06.01.2021			RECOMMENDED	PROF. S.A.S. KULATHILAKA	Amod	
PROJECT / DRAWING No. REVISION RI VMMP/WORKS/NCB/04c/11-BR/DR- 04a 00			APPROVED	K.N. BANDARA		

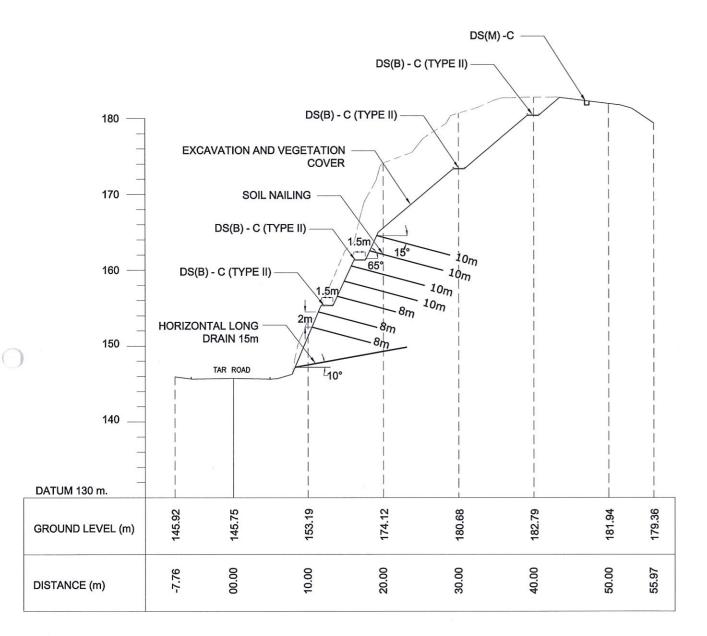




1. LOCATION, LENGTH AND NUMBER OF SOIL NAILS MIGHT BE VARIED ACCORDING TO THE SITE CONDITION ENCOUNTERED DURING CONSTRUCTION.

DESIGNER

2. ANGLE, LOCATION, LENGTH AND NUMBER OF HORIZONTAL DRAINS MIGHT BE VARIED ACCORDING TO THE SITE CONDITION ENCOUNTERED DURING CONSTRUCTION.

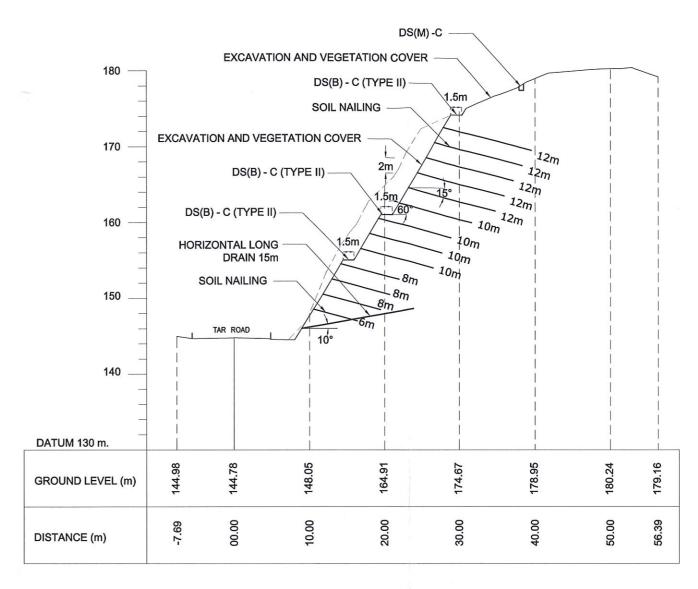

CROSS SECTION - 18


EMPLOYER DEMOCRATIC SOCIALIST REPUBLIC OF SRI LANKA STATE MINISTRY OF INTERNAL SECURITY, HOME AFFAIRS AND DISASTER MANAGEMENT NATIONAL BUILDING RESEARCH ORGANISATION No. 99/1 ,JAWATTA ROAD COLOMBO - 05

DESIGN UNIT NATIONAL BUILDING RESEARCH ORGANISATION No. 99/1 ,JAWATTA ROAD COLOMBO - 05


REDUCTION OF LANDSLIDE **VULNERABILITY BY MITIGATION MEASURES** RECTIFICATION OF LANDSLIDE IN **KEGALLE BY PASS**

REV DATE REVISION DESCRIPTION | APPROVAL PROJECT TITLE

DESCRIPTION NAME B.V.S. PATTRISHIYA DESIGN CROSS SECTION B.I. KUMARAGE DESIGNER OF PROPOSED MITIGATION MEASURES J.P. SAMARANAYAKE CHECKED RECOMMENDED PROF. S.A.S. KULATHILAKA DATE 06.01.2021 SCALE 1:500 PROJECT / DRAWING No. REVISION K.N. BANDARA APPROVED RLVMMP/WORKS/NCB/04c/11-BR/DR-04b

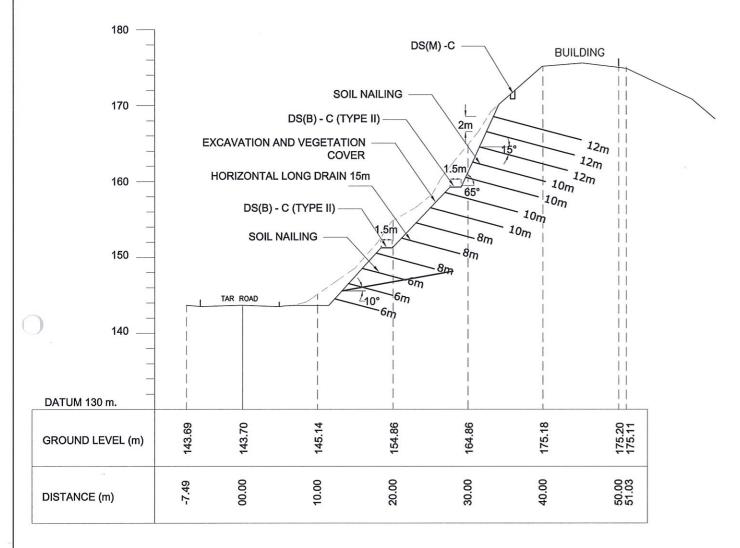

CROSS SECTION - 20

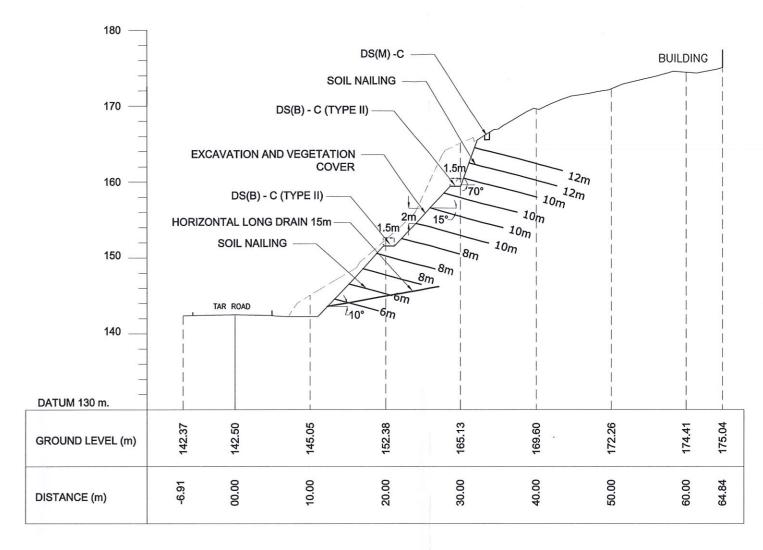

CROSS SECTION - 22

NOTES

- 1. LOCATION, LENGTH AND NUMBER OF SOIL NAILS MIGHT BE VARIED ACCORDING TO THE SITE CONDITION ENCOUNTERED DURING CONSTRUCTION.
- 2. ANGLE, LOCATION, LENGTH AND NUMBER OF HORIZONTAL DRAINS MIGHT BE VARIED ACCORDING TO THE SITE CONDITION ENCOUNTERED DURING CONSTRUCTION.

EMPLOYER

DEMOCRATIC SOCIALIST REPUBLIC OF SRI LANKA

STATE MINISTRY OF INTERNAL SECURITY, HOME AFFAIRS

AND DISASTER MANAGEMENT

NATIONAL BUILDING RESEARCH ORGANISATION

No. 99/1, JAWATTA ROAD

COLOMBO - 05

DESIGNER

DESIGN UNIT

NATIONAL BUILDING RESEARCH ORGANISATION

No. 99/1 ,JAWATTA ROAD

COLOMBO - 05


REDUCTION OF LANDSLIDE

VULNERABILITY BY MITIGATION MEASURES

RECTIFICATION OF LANDSLIDE IN


KEGALLE BY PASS

REV DATE REVISION DESCRIPTION | APPROVAL PROJECT TITLE

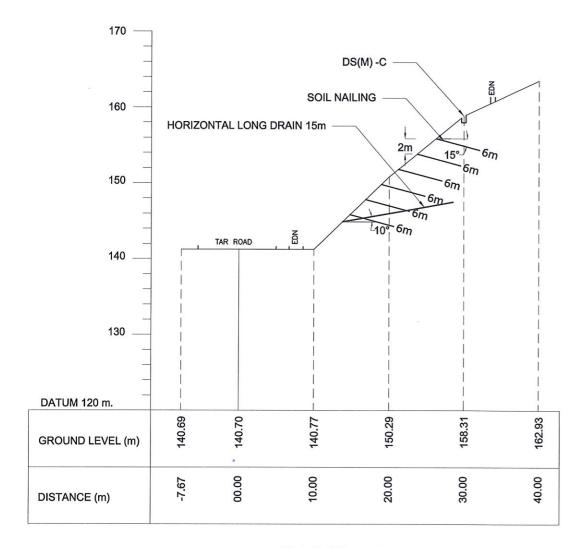

CROSS SECTION - 25

- 1. LOCATION, LENGTH AND NUMBER OF SOIL NAILS MIGHT BE VARIED ACCORDING TO THE SITE CONDITION ENCOUNTERED DURING CONSTRUCTION.
- 2. ANGLE, LOCATION, LENGTH AND NUMBER OF HORIZONTAL DRAINS MIGHT BE VARIED ACCORDING TO THE SITE CONDITION ENCOUNTERED DURING CONSTRUCTION.

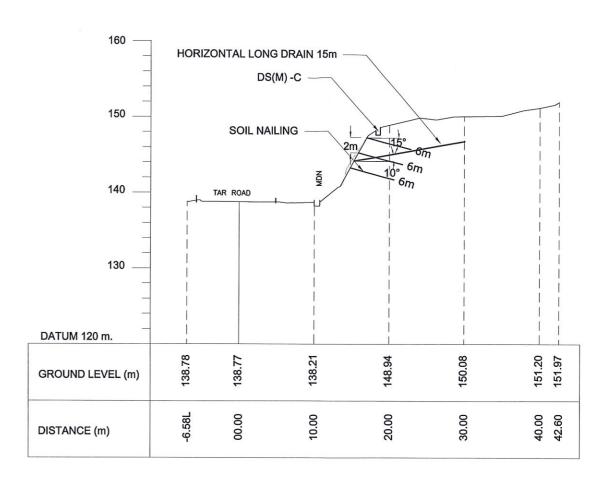

CROSS SECTION - 28

EMPLOYER

DEMOCRATIC SOCIALIST REPUBLIC OF SRI LANKA

STATE MINISTRY OF INTERNAL SECURITY, HOME AFFAIRS
AND DISASTER MANAGEMENT
NATIONAL BUILDING RESEARCH ORGANISATION
No. 99/1 ,JAWATTA ROAD
COLOMBO - 05

DESIGNER

DESIGN UNIT

NATIONAL BUILDING RESEARCH ORGANISATION

No. 99/1 ,JAWATTA ROAD

COLOMBO - 05

REV DATE REVISION DESCRIPTION APPROVAL PROJECT TITLE


REDUCTION (

VULNERABILITY BY M

RECTIFICATION (

KEGALLE

TLE				DESCRIPTION	NAME	SIGNATURE
	DESIGN CROSS	SECTIO	N	DRAWN	B.V.S. PATTRISHIYA	R
FP	ROPOSED MITIGA	TION ME	ASURES	DESIGNER	B.I. KUMARAGE	Aug .
				CHECKED	J.P. SAMARANAYAKE	high
ALE	1:500	DATE	06.01.2021	RECOMMENDED	PROF. S.A.S. KULATHILAKA	M
ROJECT / DRAWING No. REVISION VMMP/WORKS/NCB/04c/11-BR/DR-04d 00				APPROVED	K.N. BANDARA	W

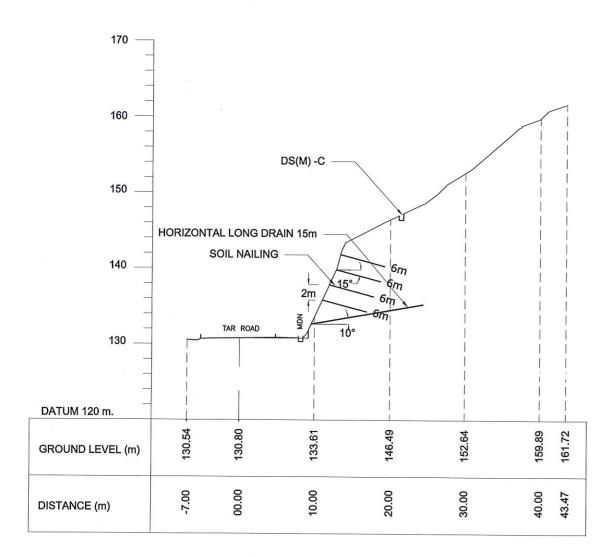

CROSS SECTION - 43

160 DS(M) -C SOIL NAILING 150 HORIZONTAL LONG DRAIN 15m 140 COLLAPSE AREA 10m 130 10m TAR ROAD 10m 120 DATUM 110 m. 158.47 GROUND LEVEL (m) 128. 10.00 -7.00 20.00 DISTANCE (m)

CROSS SECTION - 48

PROJECT / DRAWING No.

RLVMMP/WORKS/NCB/04c/11-BR/DR-04e

NOTES

- 1. LOCATION, LENGTH AND NUMBER OF SOIL NAILS MIGHT BE VARIED ACCORDING TO THE SITE CONDITION ENCOUNTERED DURING CONSTRUCTION.
- 2. ANGLE, LOCATION, LENGTH AND NUMBER OF HORIZONTAL DRAINS MIGHT BE VARIED ACCORDING TO THE SITE CONDITION ENCOUNTERED DURING CONSTRUCTION.

DEMOCRATIC SOCIALIST REPUBLIC OF SRI LANKA

STATE MINISTRY OF INTERNAL SECURITY, HOME AFFAIRS
AND DISASTER MANAGEMENT

NATIONAL BUILDING RESEARCH ORGANISATION
NO. 99/1, JAWATTA ROAD

COLOMBO. 05

DESIGNER

DESIGN UNIT

NATIONAL BUILDING RESEARCH ORGANISATION

No. 99/1 ,JAWATTA ROAD

COLOMBO - 05

REV DATE REVISION DESCRIPTION | APPROVAL PROJECT TITLE

REDUCTION OF LANDSLIDE

VULNERABILITY BY MITIGATION MEASURES

RECTIFICATION OF LANDSLIDE IN

KEGALLE BY PASS

170

DESIGN CROSS SECTION

OF PROPOSED MITIGATION MEASURES

CHECKED

SCALE 1:500

DATE 06.01.2021

RECOMMEN


DESCRIPTION NAME SIGNATURE
DRAWN B.V.S. PATTRISHIYA

DESIGNER B.I. KUMARAGE

CHECKED J.P. SAMARANAYAKE


RECOMMENDED PROF. S.A.S. KULATHILAKA

APPROVED K.N. BANDARA

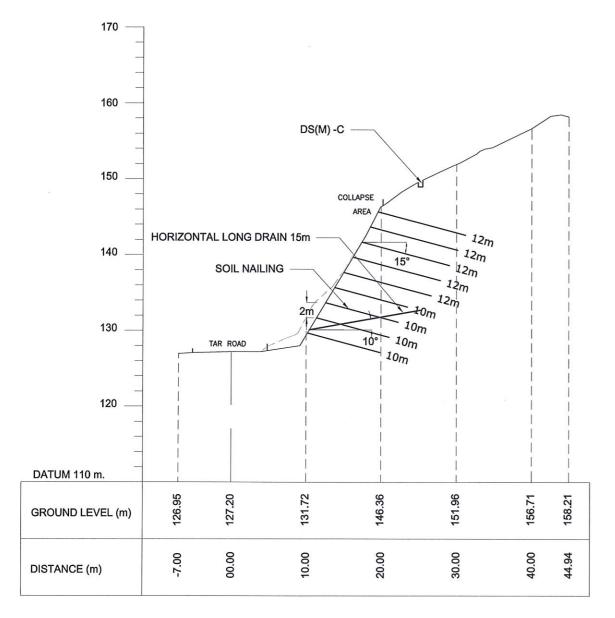

CROSS SECTION - 50

- 1. LOCATION, LENGTH AND NUMBER OF SOIL NAILS MIGHT BE VARIED ACCORDING TO THE SITE CONDITION ENCOUNTERED DURING CONSTRUCTION.
- 2. ANGLE, LOCATION, LENGTH AND NUMBER OF HORIZONTAL DRAINS MIGHT BE VARIED ACCORDING TO THE SITE CONDITION ENCOUNTERED DURING CONSTRUCTION.

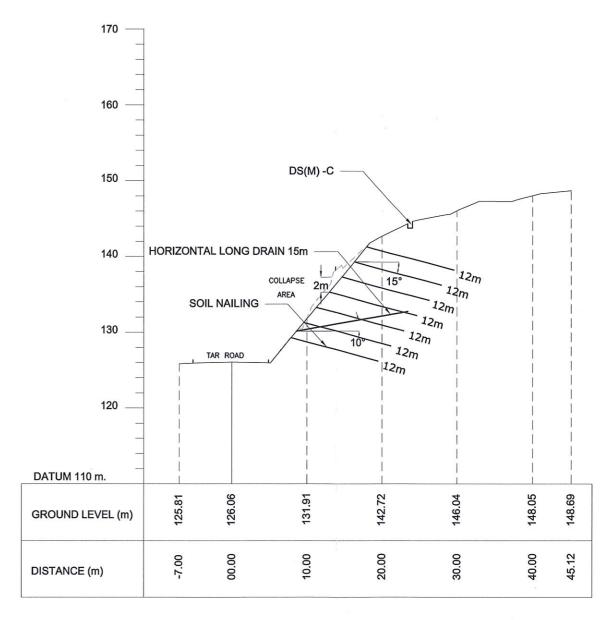

CROSS SECTION - 52


REV DATE REVISION DESCRIPTION | APPROVAL PROJECT TITLE DESIGNER **DESIGN UNIT** AND DISASTER MANAGEMENT NATIONAL BUILDING RESEARCH ORGANISATION No. 99/1 ,JAWATTA ROAD No. 99/1 ,JAWATTA ROAD COLOMBO - 05

DESCRIPTION B.V.S. PATTRISHIYA DRAWN DESIGN CROSS SECTION REDUCTION OF LANDSLIDE DESIGNER B.I. KUMARAGE OF PROPOSED MITIGATION MEASURES VULNERABILITY BY MITIGATION MEASURES CHECKED J.P. SAMARANAYAKE RECTIFICATION OF LANDSLIDE IN RECOMMENDED PROF. S.A.S. KULATHILAKA SCALE 1:500 DATE 06.01.2021 **KEGALLE BY PASS** PROJECT / DRAWING No. REVISION K.N. BANDARA

RLVMMP/WORKS/NCB/04c/11-BR/DR-04f

EMPLOYER

DEMOCRATIC SOCIALIST REPUBLIC OF SRI LANKA STATE MINISTRY OF INTERNAL SECURITY, HOME AFFAIRS NATIONAL BUILDING RESEARCH ORGANISATION

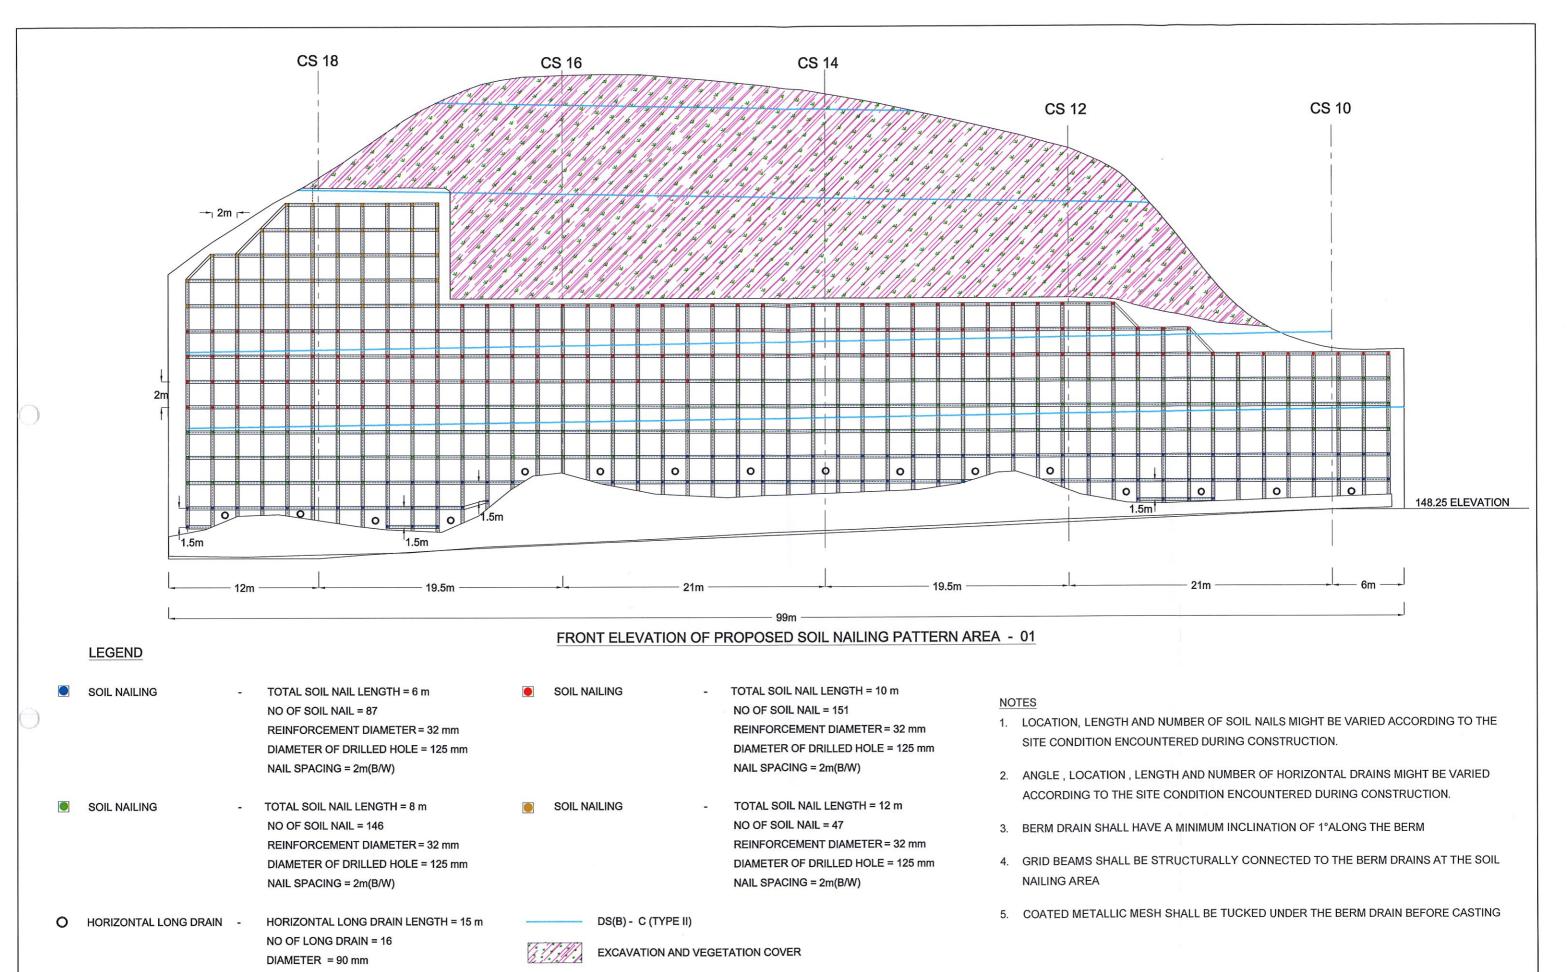

REV DATE REVISION DESCRIPTION | APPROVAL PROJECT TITLE

EMPLOYER DEMOCRATIC SOCIALIST REPUBLIC OF SRI LANKA STATE MINISTRY OF INTERNAL SECURITY, HOME AFFAIRS AND DISASTER MANAGEMENT NATIONAL BUILDING RESEARCH ORGANISATION No. 99/1 ,JAWATTA ROAD COLOMBO - 05


DESIGNER **DESIGN UNIT** NATIONAL BUILDING RESEARCH ORGANISATION No. 99/1 ,JAWATTA ROAD COLOMBO - 05

REDUCTION OF LANDSLIDE **VULNERABILITY BY MITIGATION MEASURES** RECTIFICATION OF LANDSLIDE IN **KEGALLE BY PASS**

NAME DRAWN B.V.S. PATTRISHIYA FRONT ELEVATION OF **B.I. KUMARAGE** PROPOSED MITIGATION MEASURES J.P. SAMARANAYAKE CHECKED PROF. S.A.S. KULATHILAKA RECOMMENDED SCALE N.T.S. DATE 06.11.2020 REVISION PROJECT / DRAWING No. K.N. BANDARA APPROVED

RLVMMP/WORKS/NCB/04c/11-BR/DR-05a

SIGNATURE

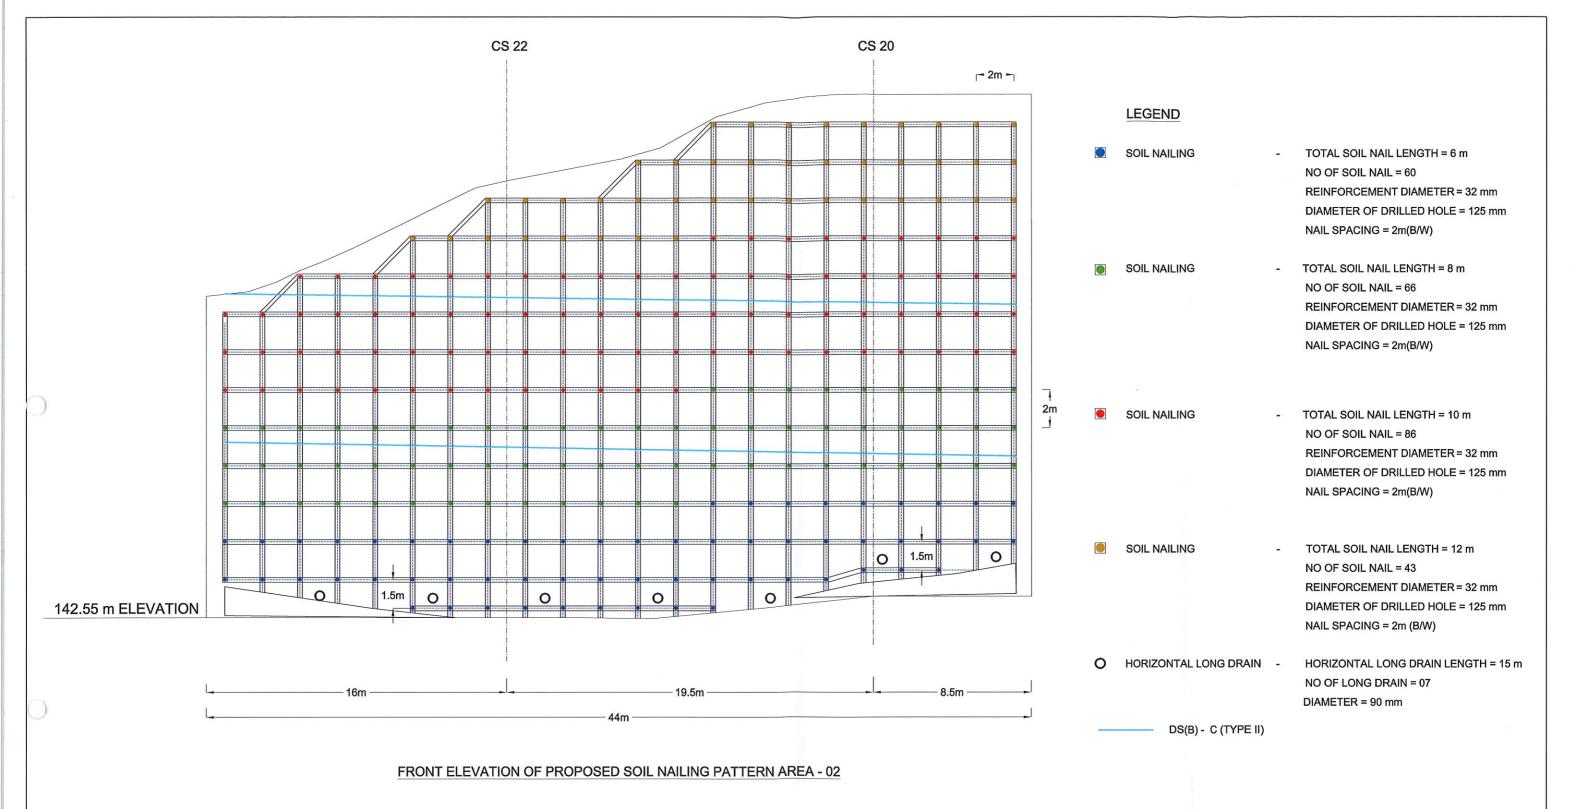

REV DATE REVISION DESCRIPTION APPROVAL PROJECT TITLE

NOTES

- 1. LOCATION, LENGTH AND NUMBER OF SOIL NAILS MIGHT BE VARIED ACCORDING TO THE SITE CONDITION ENCOUNTERED DURING CONSTRUCTION.
- 2. ANGLE, LOCATION, LENGTH AND NUMBER OF HORIZONTAL DRAINS MIGHT BE VARIED ACCORDING TO THE SITE CONDITION ENCOUNTERED DURING CONSTRUCTION.
- 3. BERM DRAIN SHALL HAVE A MINIMUM INCLINATION OF 1°ALONG THE BERM

- 4. GRID BEAMS SHALL BE STRUCTURALLY CONNECTED TO THE BERM DRAINS AT THE SOIL NAILING AREA
- 5. COATED METALLIC MESH SHALL BE TUCKED UNDER THE BERM DRAIN BEFORE CASTING

EMPLOYER

DEMOCRATIC SOCIALIST REPUBLIC OF SRI LANKA

STATE MINISTRY OF INTERNAL SECURITY, HOME AFFAIRS

AND DISASTER MANAGEMENT


NATIONAL BUILDING RESEARCH ORGANISATION

No. 99/1 ,JAWATTA ROAD


COLOMBO - 05



TITLE				DESCRIPTION	NAME	SIGNATURE
	FRONT ELEVA	TION OF	:	DRAWN	B.V.S. PATTRISHIYA	A
PROPOSED MITIGATION MEASURES				DESIGNER	B.I. KUMARAGE	Ains
					J.P. SAMARANAYAKE	14
CALE		DATE	06.11.2020	RECOMMENDED	PROF. S.A.S. KULATHILAKA	all and
ROJECT / DRAWING No. REVISION 8LVMMP/WORKS/NCB/04c/11-BR/DR- 05b 00				APPROVED	K.N. BANDARA	
						-

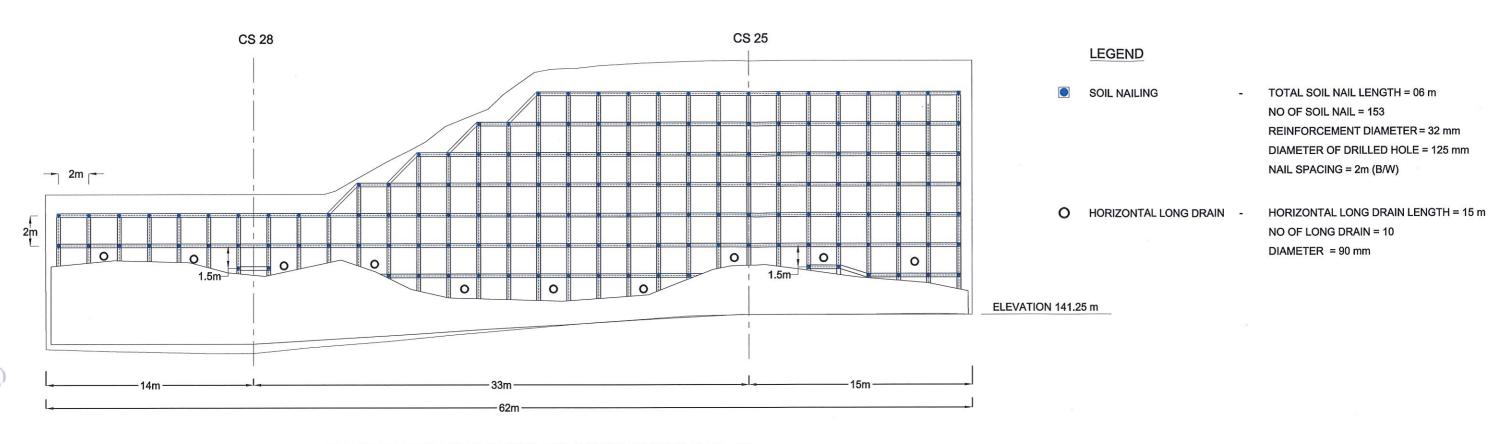

FRONT ELEVATION OF PROPOSED SOIL NAILING PATTERN AREA - 03

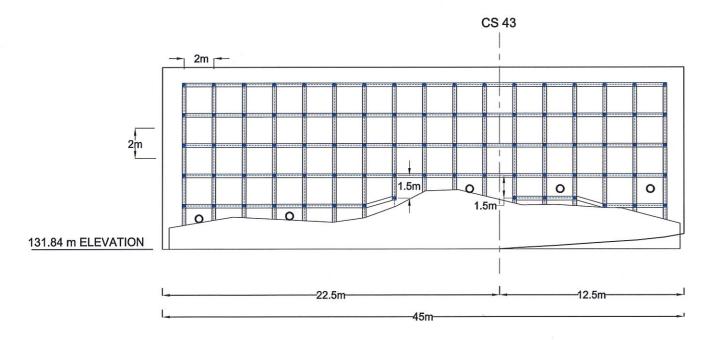

FRONT ELEVATION OF PROPOSED SOIL NAILING PATTERN AREA - 04

LEGEND

SOIL NAILING

TOTAL SOIL NAIL LENGTH = 06 m

NO OF SOIL NAIL = 82

REINFORCEMENT DIAMETER = 32 mm

DIAMETER OF DRILLED HOLE = 125 mm

NAIL SPACING = 2m (B/W)

O HORIZONTAL LONG DRAIN -


HORIZONTAL LONG DRAIN LENGTH = 15 m


NO OF LONG DRAIN = 05

DIAMETER = 90 mm

NOTES

- 1. LOCATION, LENGTH AND NUMBER OF SOIL NAILS MIGHT BE VARIED ACCORDING TO THE SITE CONDITION ENCOUNTERED DURING CONSTRUCTION.
- 2. ANGLE, LOCATION, LENGTH AND NUMBER OF HORIZONTAL DRAINS MIGHT BE VARIED ACCORDING TO THE SITE CONDITION ENCOUNTERED DURING CONSTRUCTION.

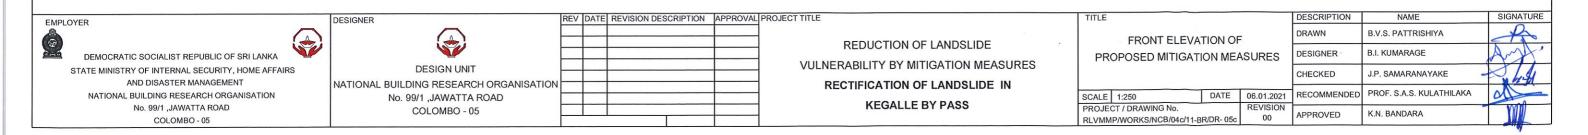

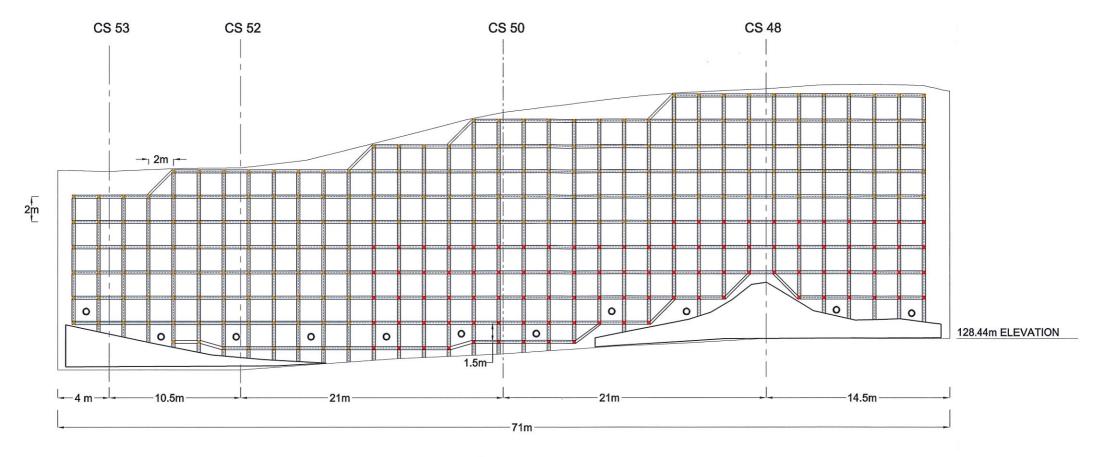

FRONT ELEVATION OF PROPOSED SOIL NAILING PATTERN AREA - 05

LEGEND

SOIL NAILING

TOTAL SOIL NAIL LENGTH = 12 m

NO OF SOIL NAIL = 199

REINFORCEMENT DIAMETER = 32 mm DIAMETER OF DRILLED HOLE = 125 mm

NAIL SPACING = 2m NAIL SPACING = 1.5m

TOTAL SOIL NAIL LENGTH = 10 m

NO OF SOIL NAIL = 99

REINFORCEMENT DIAMETER = 32 mm DIAMETER OF DRILLED HOLE = 125 mm

NAIL SPACING = 2m (B/W)

HORIZONTAL LONG DRAIN -

SOIL NAILING

HORIZONTAL LONG DRAIN LENGTH = 15 m

NO OF LONG DRAIN = 11 DIAMETER = 90 mm

NOTES

- 1. LOCATION, LENGTH AND NUMBER OF SOIL NAILS MIGHT BE VARIED ACCORDING TO THE SITE CONDITION ENCOUNTERED DURING CONSTRUCTION.
- 2. ANGLE, LOCATION, LENGTH AND NUMBER OF HORIZONTAL DRAINS MIGHT BE VARIED ACCORDING TO THE SITE CONDITION ENCOUNTERED DURING CONSTRUCTION.

EMPLOYER

DEMOCRATIC SOCIALIST REPUBLIC OF SRI LANKA STATE MINISTRY OF INTERNAL SECURITY, HOME AFFAIRS AND DISASTER MANAGEMENT NATIONAL BUILDING RESEARCH ORGANISATION


No. 99/1 ,JAWATTA ROAD

COLOMBO - 05


DESIGNER DESIGN UNIT NATIONAL BUILDING RESEARCH ORGANISATION No. 99/1 ,JAWATTA ROAD COLOMBO - 05


REV DATE REVISION DESCRIPTION | APPROVAL PROJECT TITLE

1	TITLE			DESCRIPTION	NAME	SIGNATURE
	FRONT ELEVA	TION OF		DRAWN	B.V.S. PATTRISHIYA	P
	PROPOSED MITIGATI			DESIGNER	B.I. KUMARAGE	And
				CHECKED	J.P. SAMARANAYAKE	164
	SCALE 1:300	DATE	06.01.2021	RECOMMENDED	PROF. S.A.S. KULATHILAKA	9
PROJECT / DRAWING No. REVISION RLVMMP/WORKS/NCB/04c/11-BR/DR-05d 00			REVISION 00	APPROVED	K.N. BANDARA	

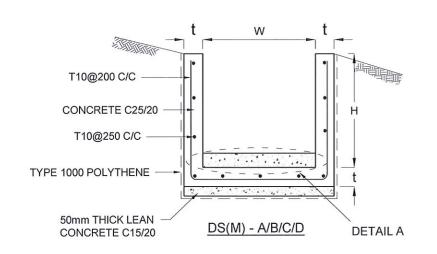

DRAIN TYPE	W (mm)	H (mm)	t (mm)
DS (M) - A /P	300	300	100
DS (M) - B/R	450	450	100
DS (M) - C/Q	600	600	100
DS (M) - D	750	750	125
DS (M) - E	900	900	150
DS (M) - F	1000	1000	150

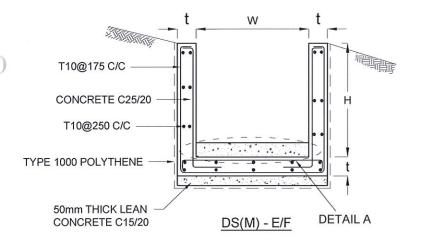

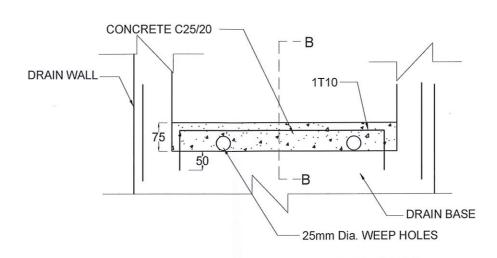

DETAIL A - (ENERGY BREAKER AT 3M)

- DEPTH OF EXCAVATION MAY VARY ACCORDING TO SITE CONDITIONS.
- STEPS SHALL BE CONSTRUCTED AT SURFACE DRAIN ON SLOPING GROUND ACCORDING TO THE SITE CONDITIONS AS INSTRUCTED BY THE ENGINEER.
- ENERGY BREAKERS SHALL BE CONSTRUCTED AT THE STEEP DRAIN SEGMENTS AS PER THE INSTRUCTIONS OF THE ENGINEER.
- 4. DOWELS SHALL BE INSTALLED ACCORDING TO THE GROUND CONDITIONS AS INSTRUCTED BY THE ENGINEER.
- 5. ALL DIMENSIONS ARE IN MILLIMETERS UNLESS OTHERWISE STATED.
- 10 mm THICK EXPANSION JOINT SHALL BE INTRODUCED IN EVERY 5m INTERVAL.


CONCRETE


[b]


- 7. USE FOLLOWING CONCRETE GRADES FOR STRUCTURE
 - [a] SCREED
- C. 15/20
- WALLS / BASE / ENERGY BREAKERS C. 25/20

REINFORCEMENT

- 8. ALL BARS MARKED "T" SHALL BE HIGH YIELD DEFORMED BARS OF YIELD STRENGTH NOT LESS THAN 460N/mm².
- BARS OF CUT LENGTH LARGER THAN THE SUPPLIED LENGTH TO BE LAPPED FOR A LENGTH OF 50 x BAR DIA. AND LAPPING SHOULD BE STAGGERED.
- 10. ANCHORAGE LENGTH SHOULD BE 40X BAR DIA.
- 11. REINFORCEMENT BARS SHALL BE BENT IN ACCORDANCE WITH STANDARD SPECIFICATIONS.
- COVER TO REINFORCEMENT
 - [a] BURIED FACES AND DRAIN INVERTS
 - [b] ALL OTHER FACES
- 40 mm - 25 mm

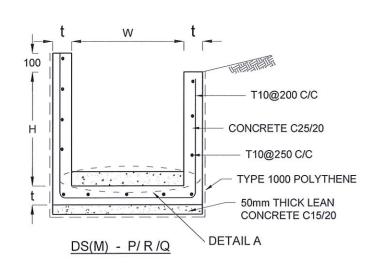

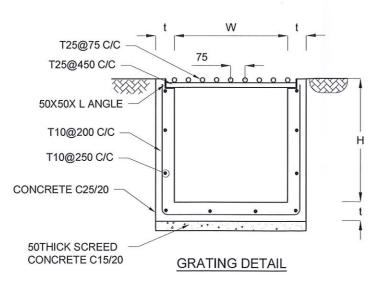

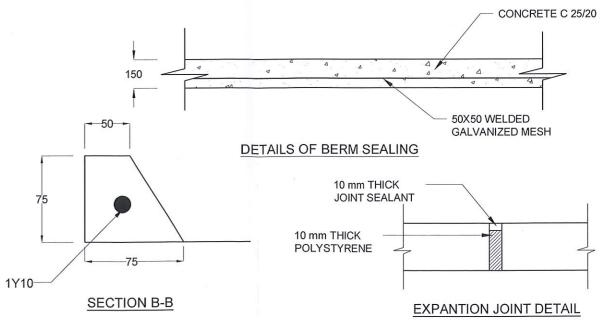

EMPLOYER

DEMOCRATIC SOCIALIST REPUBLIC OF SRI LANKA

STATE MINISTRY OF INTERNAL SECURITY, HOME AFFAIRS
AND DISASTER MANAGEMENT

NATIONAL BUILDING RESEARCH ORGANISATION
NO. 99/1 ,JAWATTA ROAD

COLOMBO - 05

DESIGNER

DESIGN UNIT

NATIONAL BUILDING RESEARCH ORGANISATION

No. 99/1 ,JAWATTA ROAD

COLOMBO - 05


REDUCTION OF LANDSLIDE

VULNERABILITY BY MITIGATION MEASURES

RECTIFICATION OF LANDSLIDE IN

KEGALLE BY PASS

SIGNATURE DESCRIPTION NAME DRAWN B.V.S. PATTRISHIYA **DETAILS OF DRAINS** B.I. KUMARAGE DESIGNER (SURFACE DRAIN -1 OF 2) J.P. SAMARANAYAKE PROF. S.A.S. KULATHILAKA 1 RECOMMENDED DATE 06.01.2021 SCALE N.T.S. REVISION PROJECT / DRAWING No **APPROVED** K.N. BANDARA RLVMMP/WORKS/NCB/04c/11-BR/DR-06a

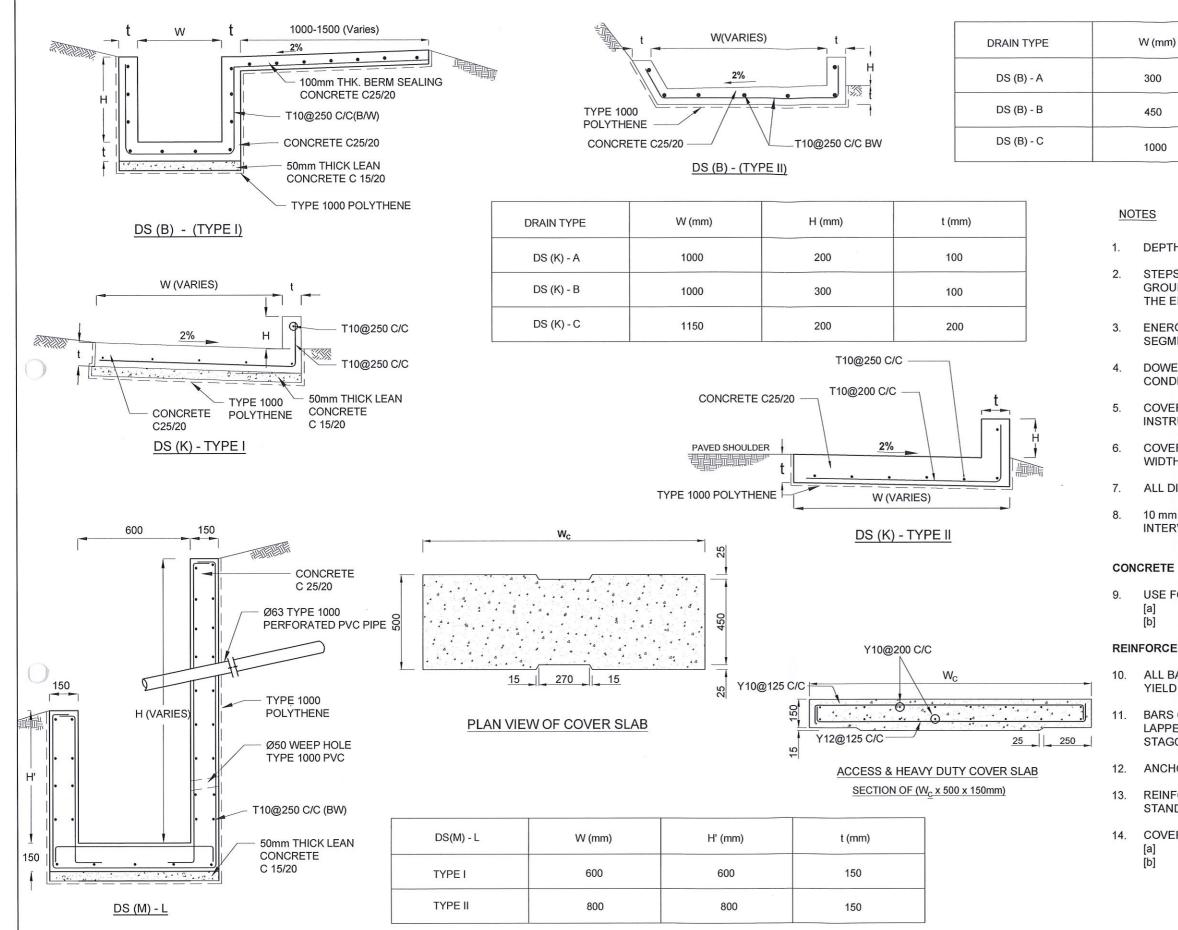

100 300 450 100 1000 150 100

H (mm)

t (mm)

- DEPTH OF EXCAVATION MAY VARY ACCORDING TO SITE CONDITIONS.
- STEPS SHALL BE CONSTRUCTED AT SURFACE DRAIN ON SLOPING GROUND ACCORDING TO THE SITE CONDITIONS AS INSTRUCTED BY THE ENGINEER.
- ENERGY BREAKERS SHALL BE CONSTRUCTED AT THE STEEP DRAIN SEGMENTS AS PER THE INSTRUCTIONS OF THE ENGINEER.
- DOWELS SHALL BE INSTALLED ACCORDING TO THE GROUND CONDITIONS AS INSTRUCTED BY THE ENGINEER.
- COVER SLABS NEED TO BE PROVIDED ONLY FOR THE REGIONS AS INSTRUCTED BY THE ENGINEER.
- COVER SLAB WIDTH (Wc) SHOULD BE TAKEN AS THE SUM OF DRAIN WIDTH AND 2x DRAIN WALL THICKNESS. [W_C = W+2xt]
- ALL DIMENSIONS ARE IN MILLIMETERS UNLESS OTHERWISE STATED.
- 10 mm THICK EXPANSION JOINT SHALL BE INTRODUCED IN EVERY 5m INTERVAL.

- USE FOLLOWING CONCRETE GRADES FOR STRUCTURE
 - SCREED - C. 15/20
 - WALLS / BASE / ENERGY BREAKERS C. 25/20

REINFORCEMENT

- ALL BARS MARKED "T" SHALL BE HIGH YIELD DEFORMED BARS OF YIELD STRENGTH NOT LESS THAN 460N/mm2.
- BARS OF CUT LENGTH LARGER THAN THE SUPPLIED LENGTH TO BE LAPPED FOR A LENGTH OF 50 x BAR DIA. AND LAPPING SHOULD BE STAGGERED.
- ANCHORAGE LENGTH SHOULD BE 40X BAR DIA.
- REINFORCEMENT BARS SHALL BE BENT IN ACCORDANCE WITH STANDARD SPECIFICATIONS.
- COVER TO REINFORCEMENT

BURIED FACES AND DRAIN INVERTS

ALL OTHER FACES

- 25 mm

- 40 mm

EMPLOYER DEMOCRATIC SOCIALIST REPUBLIC OF SRI LANKA STATE MINISTRY OF INTERNAL SECURITY, HOME AFFAIRS AND DISASTER MANAGEMENT NATIONAL BUILDING RESEARCH ORGANISATION No. 99/1 ,JAWATTA ROAD

COLOMBO - 05

DESIGNER

DESIGN UNIT NATIONAL BUILDING RESEARCH ORGANISATION No. 99/1 ,JAWATTA ROAD COLOMBO - 05

REV DATE REVISION DESCRIPTION | APPROVAL PROJECT TITLE

REDUCTION OF LANDSLIDE **VULNERABILITY BY MITIGATION MEASURES** RECTIFICATION OF LANDSLIDE IN **KEGALLE BY PASS**

DESCRIPTION NAME B.V.S. PATTRISHIYA DRAWN **DETAILS OF DRAINS** DESIGNER **B.I. KUMARAGE** (SURFACE DRAIN -2 OF 2) J.P. SAMARANAYAKE CHECKED RECOMMENDE PROF. S.A.S. KULATHILAKA SCALE N.T.S. 06.01.2021 REVISION PROJECT / DRAWING No K.N. BANDARA APPROVED RI VMMP/WORKS/NCB/04c/11-BR/DR-06b

